

浙江联和电子有限公司

ZHEJIANG LIANHE ELECTRONICS CO., LTD.

承 认 书 SPECIFICATION FOR APPROVAL

客户名称 CUSTOMER	
品名 DESCRIPTION	PHB型压接式条形连接器
料号 CUSERTOMER PART NO	A2005
日期 DATE	

客户确认 (APPROVED SIGNATURES)

核准 (APPROVAL)	工程 (ENGINEERING)	品管 (QC)
承认结果： <input type="checkbox"/> 承认 <input type="checkbox"/> 不承认 <input type="checkbox"/> 重新送样		



浙江联和电子有限公司
ZHEJIANG LIANHE ELECTRONICS CO., LTD.
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核准 (APPROVAL)	确认 (CHECK)	制作 (PREPARE)

壳体料号命名规则

Housing Part No. Naming Rules

A 2501 - S H B 02 X2 - * - ** - ** - **

A:Wire to Board Connectors
 B:Board-in Connectors
 C:Wire to Wire Connectors
 D:Hard Splices Connectors
 F:FFC/FPC Connectors
 I:IDC

系列号 Series Number

Feature Category 特征类别 (默认空)

产品类别
 Product Category:
 H=壳体 Housing
 P=密封件 Water Proofing
 F=配件 Fitting

同类别多型号序号 (默认空)

Same Series Different Type: B~ZZ

单列极数 The Pin Number of Single Row: 01~**

多列极数 The Pin Number of Several Row: X2~X*(无则空)

壳体材料
 Housing Material:
 1=PA66
 2=PA66=G=灼热丝增强
 3=PA46
 4=PA6T
 5=PA9T
 6=PBT
 7=PP0
 8=LCP
 9=U=PA66-UL

壳体材料特性
 Housing Material Specialty:
 V2 UL阻燃等级标准 (默认不注明)
 V0 UL阻燃等级标准
 Z=灼热丝是按照 (IEC60695/GB/T5169) 标准,
 符合GWIT750°C, GWF1960°C

壳体颜色
 Housing Color:
 OR=橙色 Orange
 P=粉色 Pink
 R=红色 Red
 VI=紫色 Violet
 Y=黄色 Yellow
 GY=灰色 Gray
 BK=黑色 Black
 G=绿色 Green
 BL=蓝色 Blue
 BR=棕色 Brown
 TR=透明白 Transparent
 W=白色 White
 EC=米色 ECRU
 TG=透明绿 Transparent Green
 壳体材料3/4/5/8默认米色
 壳体材料7默认黑色
 壳体材料1/2/6/9默认白色
 (默认可为空)

客户专用代码
 Customer Special Code:表示和常规件不同,用来代表某个客户

备注:*部分内容只在产品标签中体现

针座料号命名规则

Wafer Part No. Naming Rules



备注: *部分内容只在产品标签中体现

端子料号命名规则

Terminal Part No. Naming Rules

A 2501 N - T 2 2 - A 30 5 - P 2

A:Wire to Board Connectors
B:Board-in Connectors
C:Wire to Wire Connectors
F:FFC/FPC Connectors
I:IDC
D:Hard Splices Connectors

系列号 Series Number

K=直形带锁 N=直形
Z=旗形带锁 Q=旗形
X=横插带锁 H=横插
Y=叉形端子 J=插片
R=环形端子 C=圆形
G=接线端子
W=鲨鱼齿端子

特征类别(默认空) B=子弹形端子
Feature Category:U=耳扒形端子

产品类别

Product Category:T=端子 Terminal

同类别多型号序号(默认空)

Same Series Different Type: 1~9

同型号多尺寸序号(默认空)

Same Type Different size: 1~9

适用线规(默认空) A=小脚 B=中脚

Applicable Wire:C=高脚 D=大脚

料带厚度单位:mm X100 (0.3X100=30 默认空)

配合厚度单位:mm X10 (0.5X10=5 默认空)

注:所有<灰色>说明,为D系列分类附加料号及说明!

S=不锈钢 Stainless Steel

材质 P=磷青铜 Phos. Bronnze

Material:B=黄铜 Brass

0=素材酸洗 None

1=镀镍 Nickel Plating

2=镀亮锡 Tin Plating

3=镀镍氩光锡 Matt Tin-Nickel Plating

4=镀铅锡 Tin-Lead Plating

5=镀铜锡 Tin-Cu Plating

6=镀镍银 Silver-Nickel Plating

7=镀镍金 Gold-Nickel Plating

8=镀镍局部金 Half Gold-Nickel Plating

表面处理 9=镀亮锡局部金 Half Gold-Tin Plating

Surface Processing: 10=镀镍亮锡 Tin-Nickel Plating

备注:表面处理内容只在产品标签中体现




PHB连接器承认图面

REV	DESCRIPTION	DATE
A/0	原始版本	E
A/1	修订版本	

安装尺寸 Mounting Measurement

立式 Straight Angle(V-Type)

卧式 Right Angle(R-Type)

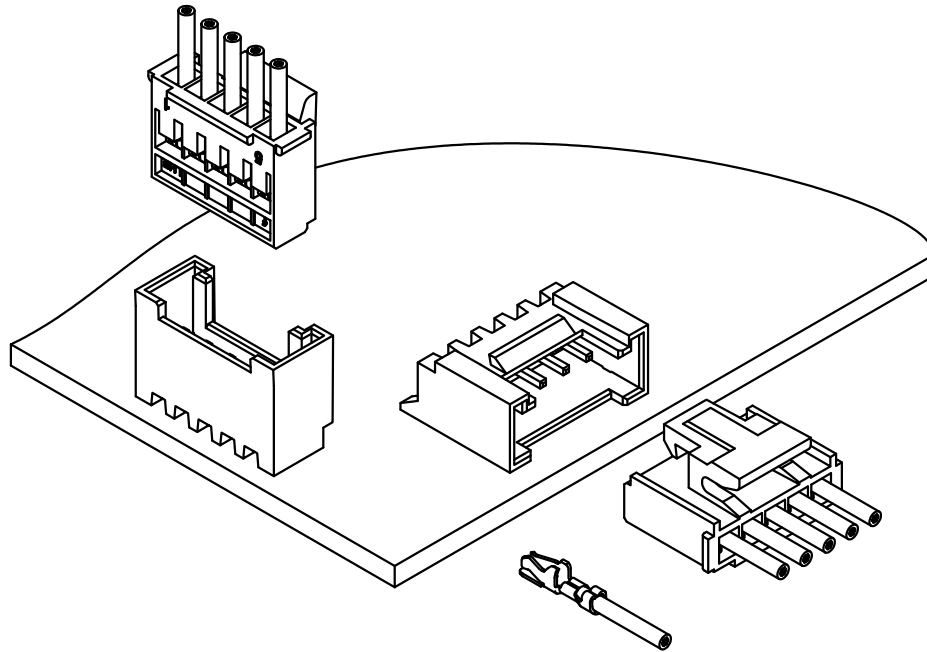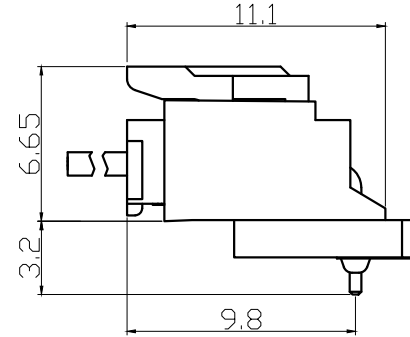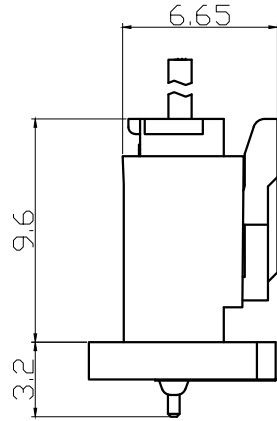

未注公差				LHE ® 浙江联和电子有限公司					
X.° ±3° X.X° ±0.5°				ZHEJIANG LIANHE ELECTRONICS CO., LTD					
>0-3	>3-18	>18-50	>50-120	单位	比例	Design Units	SIZE	页码	
±0.12	±0.15	±0.3	±0.5	MM Only	—	METRIC	A4		
制作	审核	批准	材料	图号	Part No.			PHB安装图示	
				见图解	品名				

旧底图总号
底图总号
签字
日期




PHB连接器承认图面

REV	DESCRIPTION	DATE
A/0	原始版本	E
A/1	修订版本	

安装尺寸 Mounting Measurement

立式 Straight Angle(V-Type)

卧式 Right Angle(R-Type)

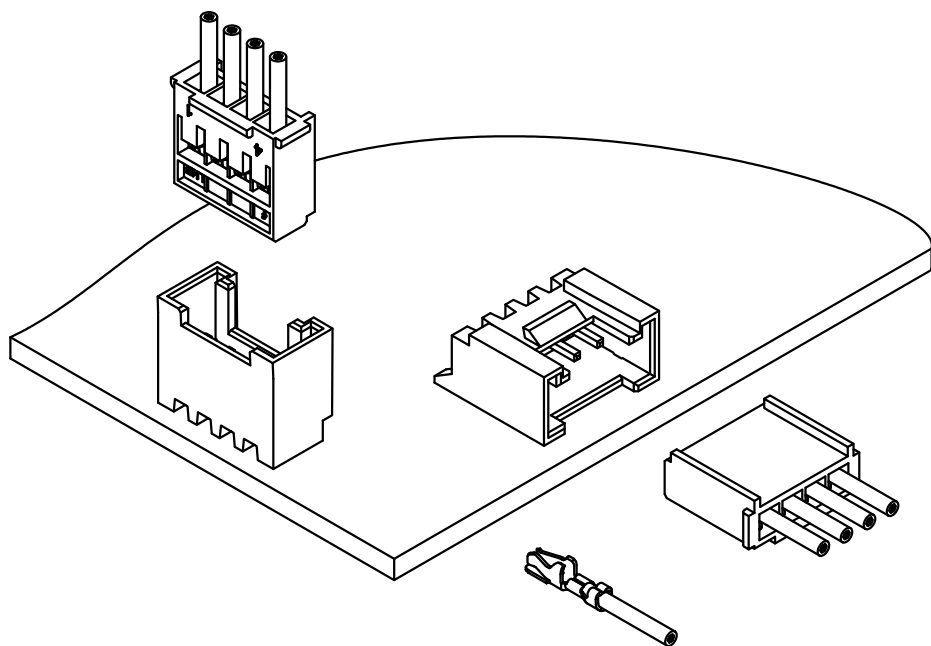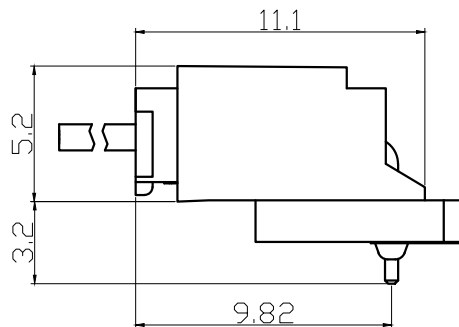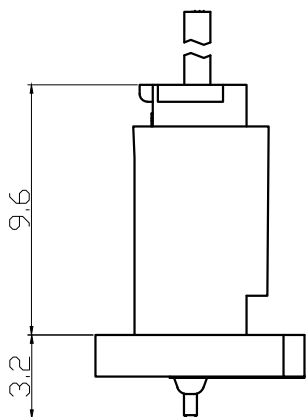

未注公差				LHE [®] 浙江联和电子有限公司					
X.° ±3° X.X° ±0.5°				ZHEJIANG LIANHE ELECTRONICS CO., LTD					
>0-3	>3-18	>18-50	>50-120	单位	比例	Design Units	SIZE	页码	
±0.12	±0.15	±0.3	±0.5	MM Only	—	METRIC	A4		
制作	审核	批准	材料	图号	Part No.				
				见图解	品名	PHB安装图示			


旧底图总号
底图总号
签字
日期

PHB连接器承认图面



REV	DESCRIPTION	DATE
A/0	原始版本	E
A/1	修订版本	

安装尺寸 Mounting Measurement

立式 Straight Angle(V-Type)

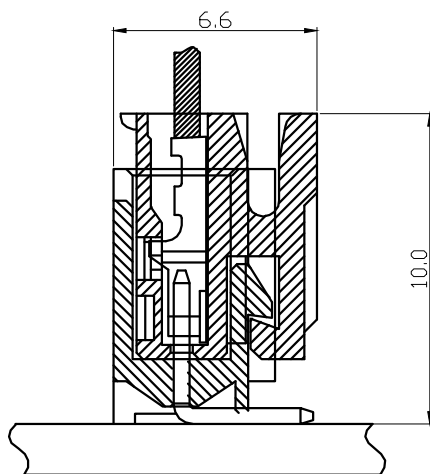

卧式 Right Angle(R-Type)

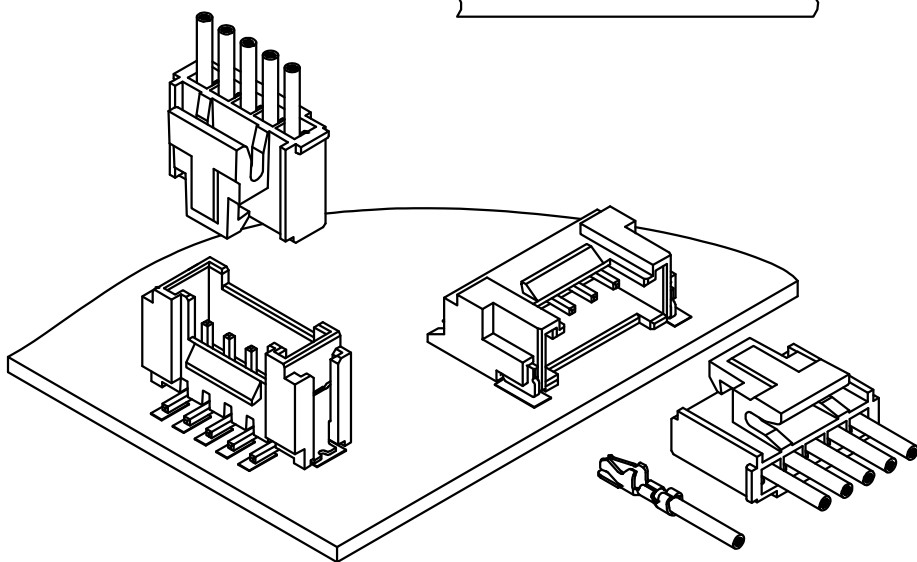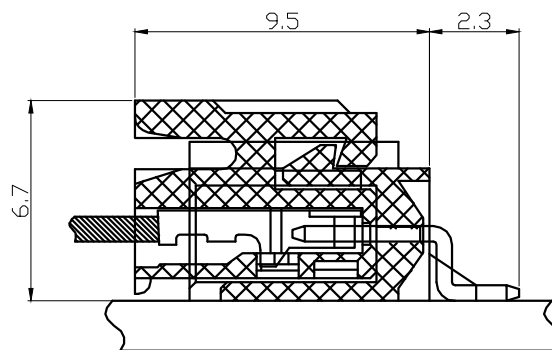


未注公差				LHE ® 浙江联和电子有限公司					
X.° ±3° X.X° ±0.5°				ZHEJIANG LIANHE ELECTRONICS CO., LTD					
>0-3	>3-18	>18-50	>50-120	单位	比例	Design Units	SIZE	页码	
±0.12	±0.15	±0.3	±0.5	MM Only	—	METRIC	A4		
制作	审核	批准	材料	图号	Part No.				
				见图解	品名	PHB安装图示			


旧底图总号
底图总号
签字
日期

PHB连接器承认图面

REV	SYM	REVISION RECORD	DR.	APPR.	DATE
A/0		原始版本			A/0
A/1		修改C尺寸	YF		20211116

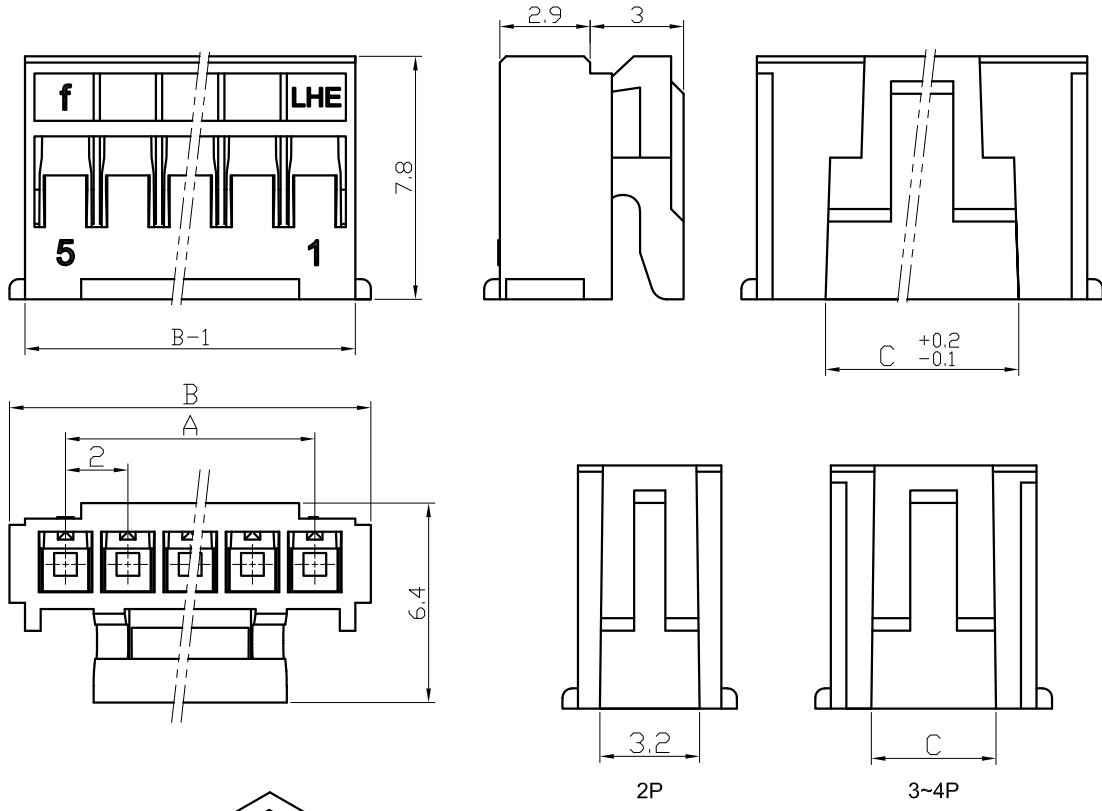

Poles	Part No.		Dimensions mm		
			A	B	C
2	A2005-H02	PHB-2Y	2.00	5.6	3.2
3	A2005-H03	PHB-3Y	4.00	7.6	4.0
4	A2005-H04	PHB-4Y	6.00	9.6	5.0
5	A2005-H05	PHB-5Y	8.00	11.6	6.0
6	A2005-H06	PHB-6Y	10.00	13.6	8.0
7	A2005-H07	PHB-7Y	12.00	15.6	10.0
8	A2005-H08	PHB-8Y	14.00	17.6	12.0
9	A2005-H09	PHB-9Y	16.00	19.6	14.0
10	A2005-H10	PHB-10Y	18.00	21.6	16.0
11	A2005-H11	PHB-11Y	20.00	23.6	14.0
12	A2005-H12	PHB-12Y	22.00	25.6	16.0
13	A2005-H13	PHB-13Y	24.00	27.6	16.0
14	A2005-H14	PHB-14Y	26.00	29.6	16.0
15	A2005-H15	PHB-15Y	28.00	31.6	16.0
16	A2005-H16	PHB-16Y	30.00	33.6	16.0
17	A2005-H17	PHB-17Y	32.00	35.6	16.0
18	A2005-H18	PHB-18Y	34.00	37.6	16.0





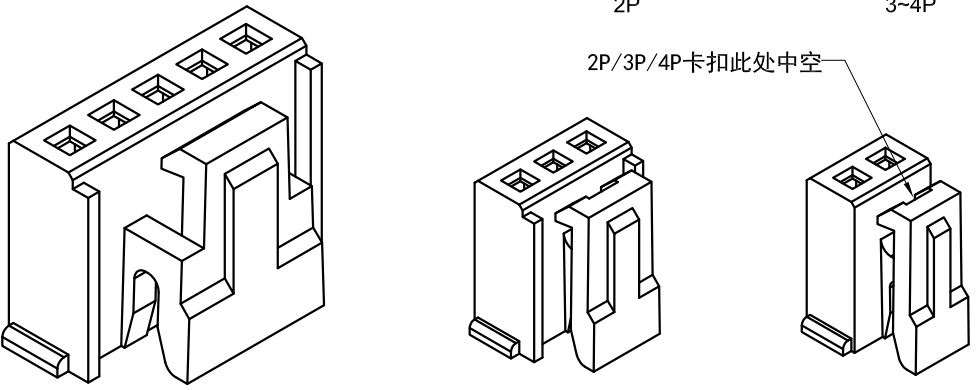


1		Housing 胶壳	PA66(UL94V-0/V-2)	1	White (白色)
序号	图号	名称	材料	数量	附注
未注公差		LHE 浙江联和电子有限公司 ZHEJIANG LIANHE ELECTRONICS CO., LTD			
X.° >0-3	±3°	X.X° >3-18	±0.5°	单位	比例
±0.12	±0.15	±0.3	±0.5	Design Units	SIZE 页码
制作		审核	批准	METRIC	A4
材料		图号	Part No.		
见图解		品名	PHB-NY		

旧底图总号
底图总号
签字
日期

PHB连接器承认图面

REV	SYM	REVISION RECORD	DR.	APPR.	DATE
A/0		原始版本			A/0
A/1		修改孔位	YF		20220303

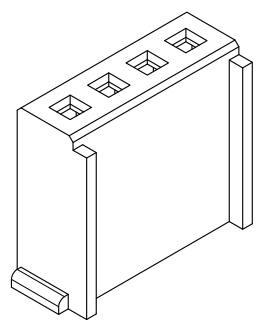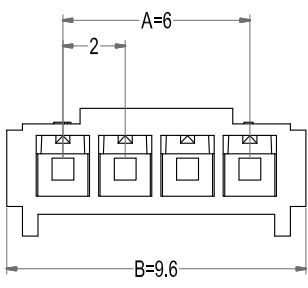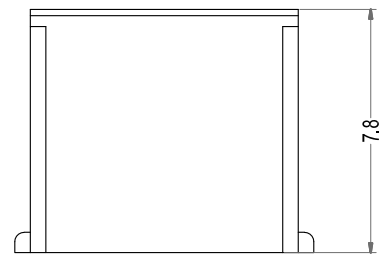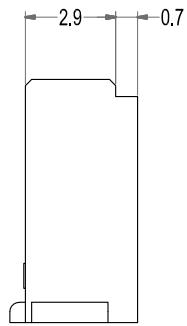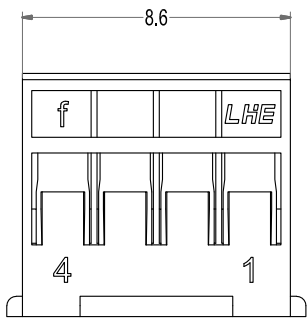




Poles	Part No.	Dimensions mm	
		A	B
4	A2005-HB04 PHB-4Y无扣	6.00	9.6

1		Housing 胶壳	PA66(UL94V-0/V-2)	1	White (白色)
序号	图号	名称	材料	数量	附注
未注公差		LHE 浙江联和电子有限公司 ZHEJIANG LIANHE ELECTRONICS CO., LTD			
X.° ±3°	X.X° ±0.5°	单位	比例	Design Units	SIZE 页码
>0-3	>3-18	>18-50	>50-120	MM Only	METRIC A4
±0.12	±0.15	±0.3	±0.5	制作	审核 批准
		材料	图号	Part No.	
		见图解	品名	PHB-4Y无扣	


旧底图总号
底图总号
签字
日期

PHB型连接器承认图面


REV	SYM	REVISION RECORD	DR.	APPR.	DATE
A/0		原始版本			A/0
A/1	①	新增T12	WZY		20190801
A/2	②	取消端子表面处理说明	YF		20220119
A/3	③	高低温环境测试从85℃,更新到105℃	YF		20221022
A/4	④	修改3D视图带圈型	YF		20230107
A/5	⑤	新增T13	SH		20230329

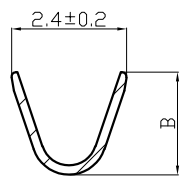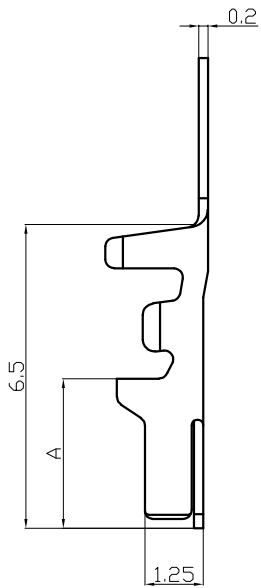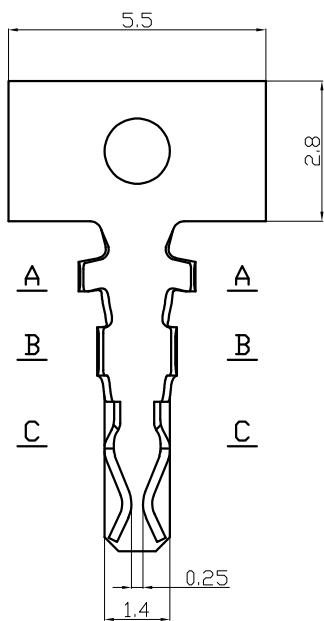


A-A

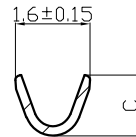

B-B

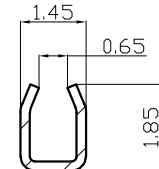

C-C

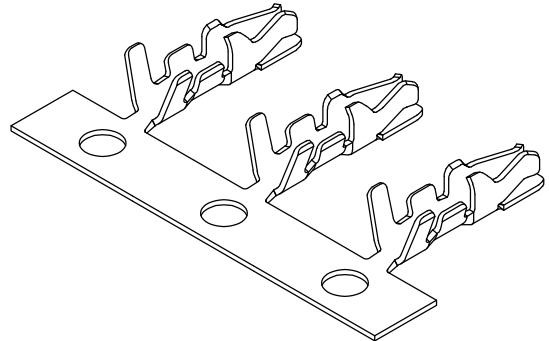

主要技术参数 Main Specifications


额定电流 (Current rating): 3.0A AC, DC
 额定电压 (Voltage rating): 250V AC, DC
 温度范围 (Temperature range): -25°C to +105°C③
 接触电阻 (Contact resistance): ≤30mΩ
 绝缘电阻 (Insulation resistance): ≥1000MΩ
 耐电压 (Withstand voltage): 1000V AC/minute
 适用线规 (Applicable wire): AWG #30 to #22
 线材绝缘外径 (Wire insulation O.D): 0.9 to 1.5mm
 线材铜丝横截面积 (Section Area mm²): 0.05 to 0.33

Part No.	A	B	C	Material	Finish	Qty/reel	
A2005-TP	PHB-T11	3.3	2.15	1.4	Phosphor Bronze	TIN	12000pcs
① A2005-T12P	PHB-T12	3.2	2.2	1.4	Phosphor Bronze	TIN	12000pcs
⑤ A2005-T13P	PHB-T13	3.3	2.15	1.75	Phosphor Bronze	TIN	12000pcs

未注公差

>0-3	>3-18	>18-50	>50-120	单位	比例	Design Units	SIZE	页码
±0.12	±0.15	±0.3	±0.5	MM Only	—	METRIC	A4	
制作	审核	批准	材料	图号	Part No.			
见图解				品名	PHB-T			



LHE® 浙江联和电子有限公司
 ZHEJIANG LIANHE ELECTRONICS CO., LTD

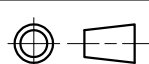

旧底图总号
 底图总号
 签字
 日期

PHB型连接器承认图面

REV	SYM	REVISION RECORD	DR.	APPR.	DATE
A/0		原始版本			A/0
A/1	①	取消端子表面处理说明	YF		20220119
A/2	②	修订端子底部链接, 保证插针稳定性	YF		20220907
A/3	③	高低温环境测试从85°C, 更新到105°C	YF		20221022
A/4	④	端子接触部位尺寸0.28改为0.38	SH		20230316

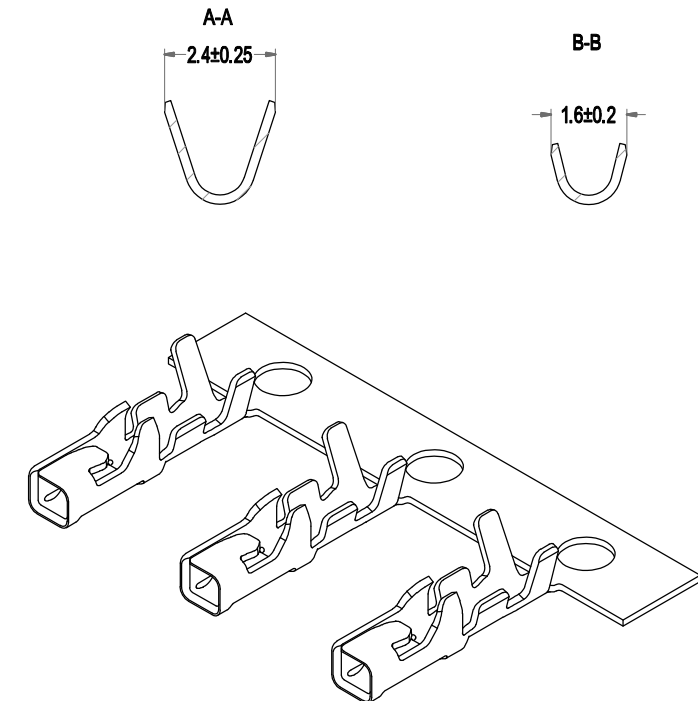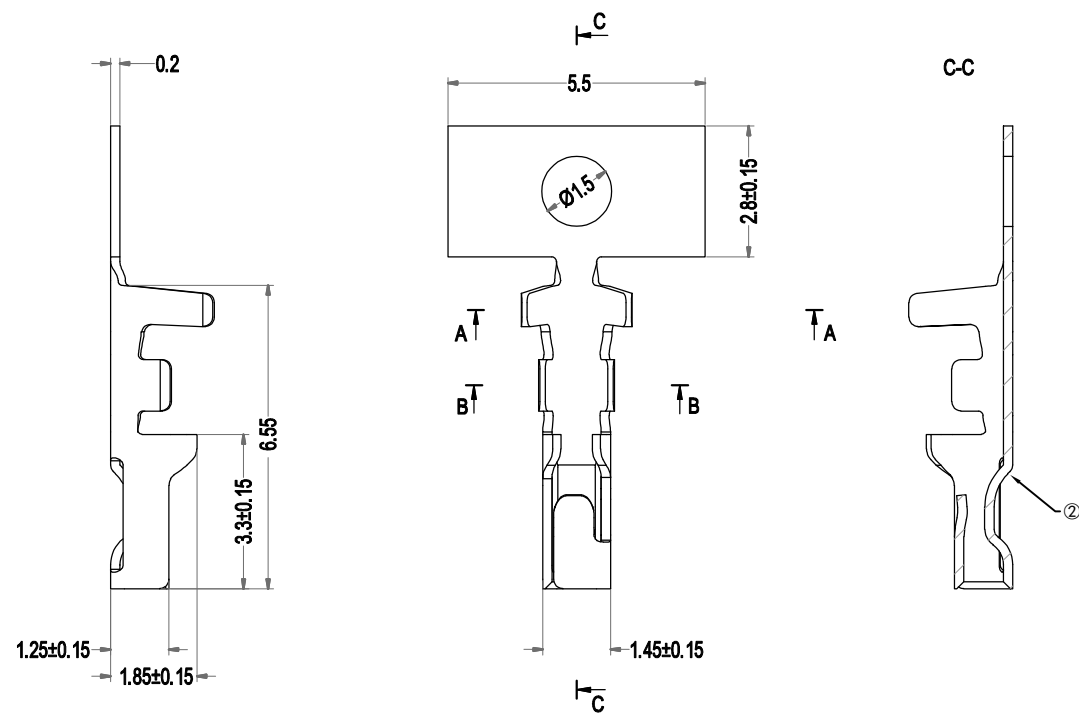

主要技术参数
Main Specifications

额定电流 (Current rating): 3.0A AC, DC
 额定电压 (Voltage rating): 250V AC, DC
 温度范围 (Temperature range): -25°C to +105°C ③
 接触电阻 (Contact resistance): ≤30mΩ
 绝缘电阻 (Insulation resistance): ≥1000MΩ
 耐电压 (Withstand voltage): 1000V AC/minute
 适用线规 (Applicable wire): AWG #30 to #22
 线材绝缘外径 (Wire insulation O.D.): 0.9 to 1.5mm
 线材铜丝横截面积 (Section Area mm²): 0.05 to 0.33





Part No.	Material	Finish	Qty/reel	
A2005-T21P	PHB-T21	Phosphor Bronze	TIN	12000pcs

未注公差				LHE [®] 浙江联和电子有限公司					
X.° ±3° X.X° ±0.5°				ZHEJIANG LIANHE ELECTRONICS CO., LTD					
>0-3	>3-18	>18-50	>50-120	单位	比例	Design Units	SIZE	页码	
±0.12	±0.15	±0.3	±0.5	MM Only	—	METRIC	A4		
制作	审核	批准	材料	图号			Part No.		
				见图解	品名	PHB-T21			

旧底图总号
底图总号
签字
日期



PHB连接器承认图面

REV	SYM	REVISION RECORD	DR.	APPR.	DATE
A/0		原始版本			A/0
A/1		提升内针长度便于目视检测增加可靠性	YF		20221022

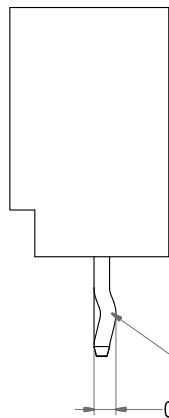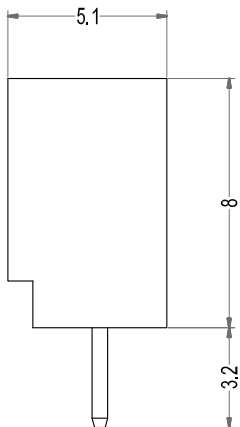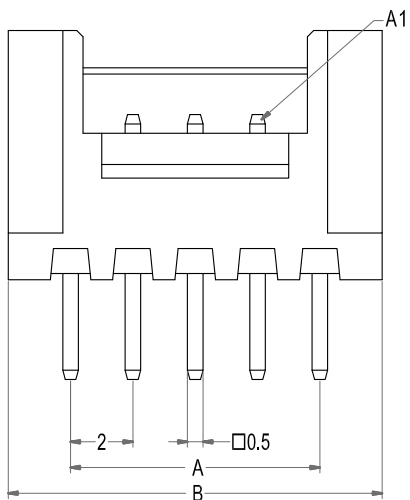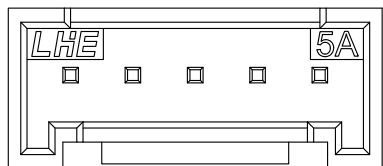


此处为打点样式
(打点位置在两边第一针)

Poles	Part No.		Dimensions mm	
	A	B	A	B
2	A2005-WV02	PHB-2A	2.0	6.0
3	A2005-WV03	PHB-3A	4.0	8.0
4	A2005-WV04	PHB-4A	6.0	10.0
5	A2005-WV05	PHB-5A	8.0	12.0
6	A2005-WV06	PHB-6A	10.0	14.0
7	A2005-WV07	PHB-7A	12.0	16.0
8	A2005-WV08	PHB-8A	14.0	18.0
9	A2005-WV09	PHB-9A	16.0	20.0
10	A2005-WV10	PHB-10A	18.0	22.0
--	--	--	--	--
17	A2005-WV17	PHB-17A	32.0	36.0
18	A2005-WV18	PHB-18A	34.0	38.0
2	A2005-WV02-K	PHB-2A打点	2.0	6.0
3	A2005-WV03-K	PHB-3A打点	4.0	8.0
4	A2005-WV04-K	PHB-4A打点	6.0	10.0
5	A2005-WV05-K	PHB-5A打点	8.0	12.0
6	A2005-WV06-K	PHB-6A打点	10.0	14.0
7	A2005-WV07-K	PHB-7A打点	12.0	16.0
8	A2005-WV08-K	PHB-8A打点	14.0	18.0
9	A2005-WV09-K	PHB-9A打点	16.0	20.0
10	A2005-WV10-K	PHB-10A打点	18.0	22.0
--	--	--	--	--
17	A2005-WV17-K	PHB-17A打点	32.0	36.0
18	A2005-WV18-K	PHB-18A打点	34.0	38.0

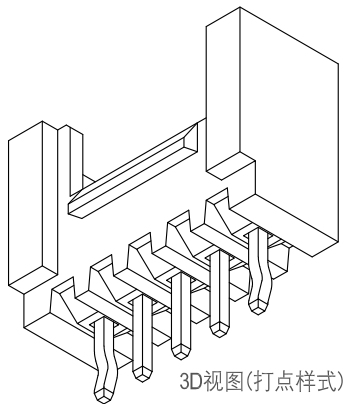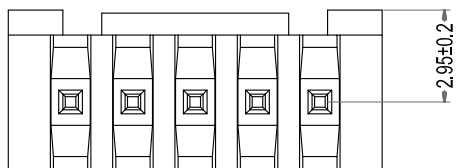

3D视图(打点样式)

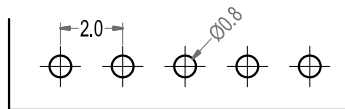






P. C. B LAYOUT

2	Wafer 针	Brass Tin 黄铜镀锡	N						
1	Housing 基座	PA66 (UL94V-0)	1	White (白色)					
序号	图号	名称	材料	数量	附注				
未注公差		LHE ® 浙江联和电子有限公司 ZHEJIANG LIANHE ELECTRONICS CO., LTD							
X.° ±3° X.X° ±0.5°									
>0-3	>3-18	>18-50	>50-120	单位	比例	Design Units	SIZE	页码	
±0.12	±0.15	±0.3	±0.5	MM Only	—	METRIC	A4		
制作	审核	批准	材料	图号	Part No.		PHB-NA		
见图解			品名						


旧底图总号
底图总号
签字
日期

PHB连接器承认图面

REV	SYM	REVISION RECORD	DR.	APPR.	DATE
A/0		原始版本			A/0
A/1					

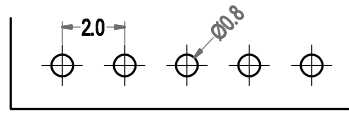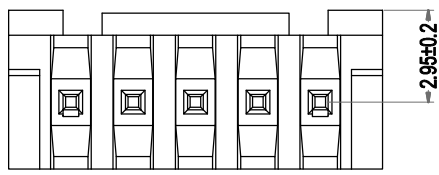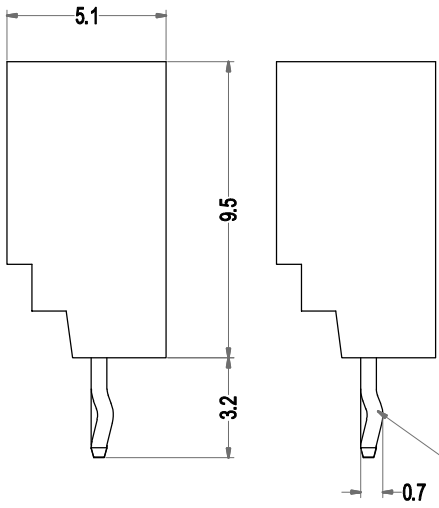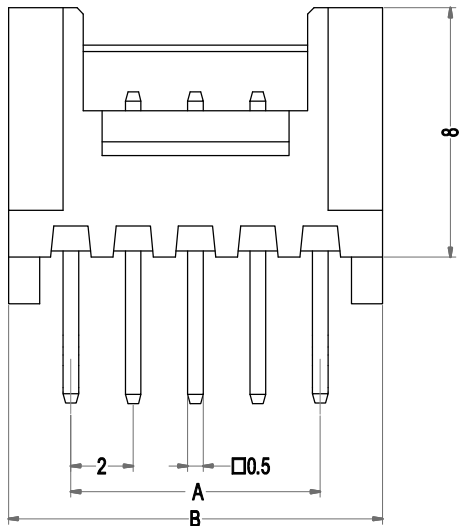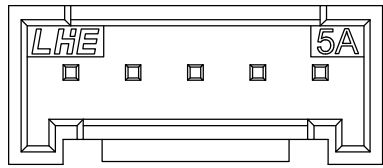

P. C. B LAYOUT

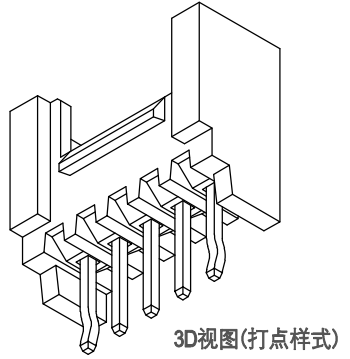





Poles	Part No.		Dimensions mm	
			A	B
2	A2005-WVB02	PHB-2AC	2.0	6.0
3	A2005-WVB03	PHB-3AC	4.0	8.0
4	A2005-WVB04	PHB-4AC	6.0	10.0
5	A2005-WVB05	PHB-5AC	8.0	12.0
6	A2005-WVB06	PHB-6AC	10.0	14.0
7	A2005-WVB07	PHB-7AC	12.0	16.0
8	A2005-WVB08	PHB-8AC	14.0	18.0
9	A2005-WVB09	PHB-9AC	16.0	20.0
10	A2005-WVB10	PHB-10AC	18.0	22.0
--	--	--	--	--
17	A2005-WVB17	PHB-17AC	32.0	36.0
18	A2005-WVB18	PHB-18AC	34.0	38.0
2	A2005-WVB02-K	PHB-2AC打点	2.0	6.0
3	A2005-WVB03-K	PHB-3AC打点	4.0	8.0
4	A2005-WVB04-K	PHB-4AC打点	6.0	10.0
5	A2005-WVB05-K	PHB-5AC打点	8.0	12.0
6	A2005-WVB06-K	PHB-6AC打点	10.0	14.0
7	A2005-WVB07-K	PHB-7AC打点	12.0	16.0
8	A2005-WVB08-K	PHB-8AC打点	14.0	18.0
9	A2005-WVB09-K	PHB-9AC打点	16.0	20.0
10	A2005-WVB10-K	PHB-10AC打点	18.0	22.0
--	--	--	--	--
17	A2005-WVB17-K	PHB-17AC打点	32.0	36.0
18	A2005-WVB18-K	PHB-18AC打点	34.0	38.0

2	Wafer 针	Brass Tin 黄铜镀锡	N						
1	Housing 基座	PA66 (UL94V-0)	White (白色)						
序号	图号	名称	材料	数量	附注				
未注公差		LHE ® 浙江联和电子有限公司 ZHEJIANG LIANHE ELECTRONICS CO., LTD							
X.° ±3° X. X° ±0.5°									
>0-3	>3-18	>18-50	>50-120	单位	比例	Design Units	SIZE	页码	
±0.12	±0.15	±0.3	±0.5	MM Only	—	METRIC	A4		
制作	审核	批准	材料	图号	Part No.				
见图解			品名	PHB-NAC					

旧底图总号
底图总号
签字
日期



PHB连接器承认图面

REV	SYM	REVISION RECORD	DR.	APPR.	DATE
A/0		原始版本			A/0
A/1		提升内针长度便于目视检测增加可靠性	YF		20221022
A/2		增加定位柱到插针尺寸(1.5)	YF		20230323

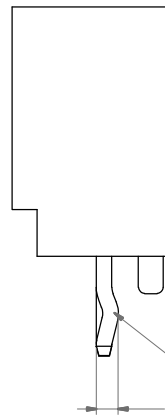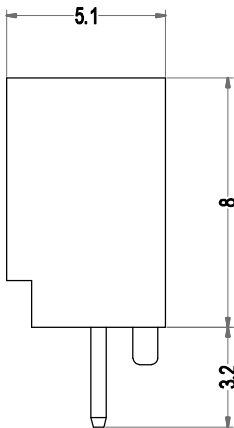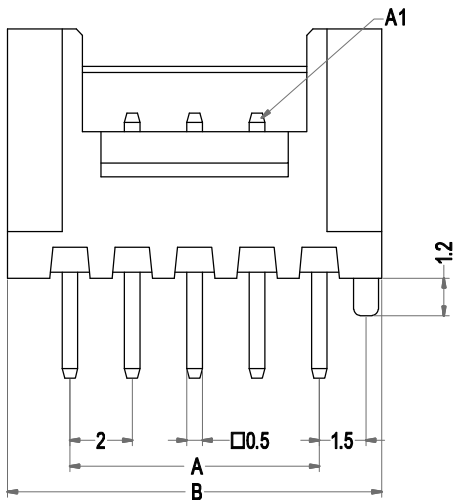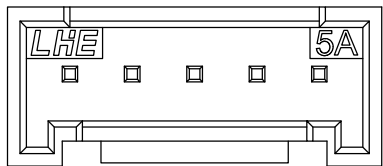


此处为打点样式
(打点位置在两边第一针)

Poles	Part No.		Dimensions mm	
	A	B	A	B
2	A2005-DWV02	PHB-2AD	2.0	6.0
3	A2005-DWV03	PHB-3AD	4.0	8.0
4	A2005-DWV04	PHB-4AD	6.0	10.0
5	A2005-DWV05	PHB-5AD	8.0	12.0
6	A2005-DWV06	PHB-6AD	10.0	14.0
7	A2005-DWV07	PHB-7AD	12.0	16.0
8	A2005-DWV08	PHB-8AD	14.0	18.0
9	A2005-DWV09	PHB-9AD	16.0	20.0
10	A2005-DWV10	PHB-10AD	18.0	22.0
--	--	--	--	--
17	A2005-DWV17	PHB-17AD	32.0	36.0
18	A2005-DWV18	PHB-18AD	34.0	38.0
2	A2005-DWV02-K	PHB-2AD打点	2.0	6.0
3	A2005-DWV03-K	PHB-3AD打点	4.0	8.0
4	A2005-DWV04-K	PHB-4AD打点	6.0	10.0
5	A2005-DWV05-K	PHB-5AD打点	8.0	12.0
6	A2005-DWV06-K	PHB-6AD打点	10.0	14.0
7	A2005-DWV07-K	PHB-7AD打点	12.0	16.0
8	A2005-DWV08-K	PHB-8AD打点	14.0	18.0
9	A2005-DWV09-K	PHB-9AD打点	16.0	20.0
10	A2005-DWV10-K	PHB-10AD打点	18.0	22.0
--	--	--	--	--
17	A2005-DWV17-K	PHB-17AD打点	32.0	36.0
18	A2005-DWV18-K	PHB-18AD打点	34.0	38.0

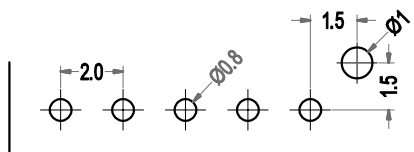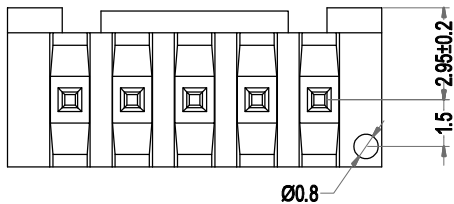

P. C. B LAYOUT

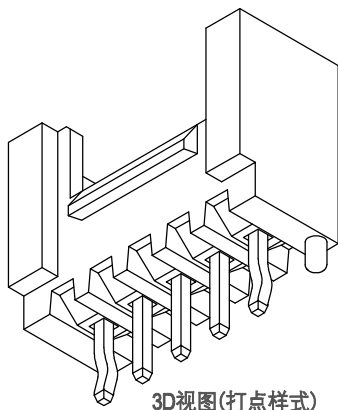





3D视图(打点样式)

2	Wafer 针	Brass Tin 黄铜镀锡	N						
1	Housing 基座	PA66 (UL94V-0)	1	White (白色)					
序号	图号	名称	材料	数量	附注				
未注公差		LHE ® 浙江联和电子有限公司 ZHEJIANG LIANHE ELECTRONICS CO., LTD							
X.° ±3° X.X° ±0.5°									
>0-3	>3-18	>18-50	>50-120	单位	比例	Design Units	SIZE	页码	
±0.12	±0.15	±0.3	±0.5	MM Only	—	METRIC	A4		
制作	审核	批准	材料	图号	Part No.				
			见图解	品名	PHB-NAD				



旧底图总号
底图总号
签字
日期

PHB连接器承认图面


REV	SYM	REVISION RECORD	DR.	APPR.	DATE
A/0		原始版本			A/0
A/1		提升内针长度便于目视检测增加可靠性	YF		20221022

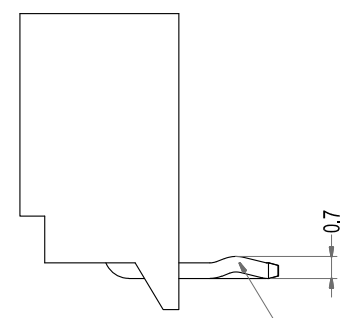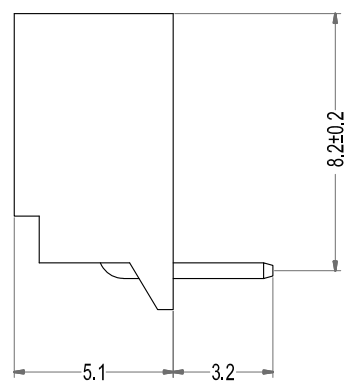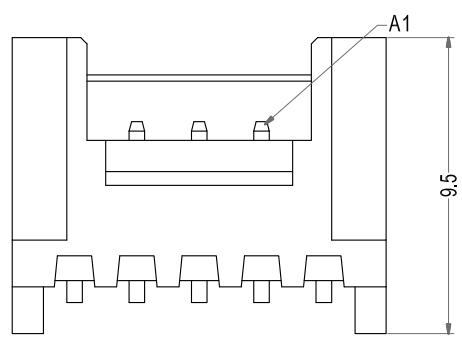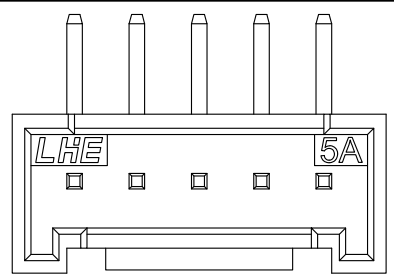

此处为打点样式
(打点位置在两边第一针)

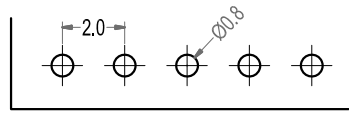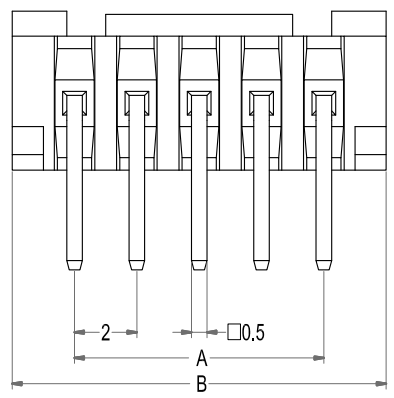

P. C. B LAYOUT

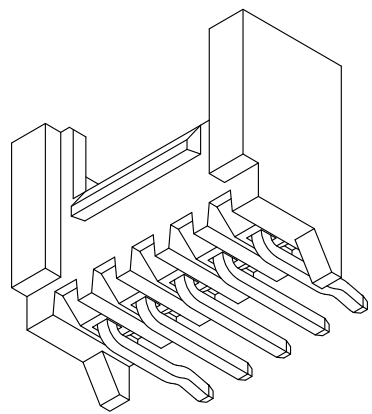

3D视图(打点样式)







Poles	Part No.		Dimensions mm	
	A	B	A	B
2	A2005-WR02	PHB-2AWD	2.0	6.0
3	A2005-WR03	PHB-3AWD	4.0	8.0
4	A2005-WR04	PHB-4AWD	6.0	10.0
5	A2005-WR05	PHB-5AWD	8.0	12.0
6	A2005-WR06	PHB-6AWD	10.0	14.0
7	A2005-WR07	PHB-7AWD	12.0	16.0
8	A2005-WR08	PHB-8AWD	14.0	18.0
9	A2005-WR09	PHB-9AWD	16.0	20.0
10	A2005-WR10	PHB-10AWD	18.0	22.0
11	A2005-WR11	PHB-11AWD	20.0	24.0
12	A2005-WR12	PHB-12AWD	22.0	26.0
13	A2005-WR13	PHB-13AWD	24.0	28.0
14	A2005-WR14	PHB-14AWD	26.0	30.0
15	A2005-WR15	PHB-15AWD	28.0	32.0
16	A2005-WR16	PHB-16AWD	30.0	34.0
17	A2005-WR17	PHB-17AWD	32.0	36.0
18	A2005-WR18	PHB-18AWD	34.0	38.0
2	A2005-WR02-K	PHB-2AWD打点	2.0	6.0
3	A2005-WR03-K	PHB-3AWD打点	4.0	8.0
4	A2005-WR04-K	PHB-4AWD打点	6.0	10.0
5	A2005-WR05-K	PHB-5AWD打点	8.0	12.0
6	A2005-WR06-K	PHB-6AWD打点	10.0	14.0
7	A2005-WR07-K	PHB-7AWD打点	12.0	16.0
8	A2005-WR08-K	PHB-8AWD打点	14.0	18.0
9	A2005-WR09-K	PHB-9AWD打点	16.0	20.0
10	A2005-WR10-K	PHB-10AWD打点	18.0	22.0
11	A2005-WR11-K	PHB-11AWD打点	20.0	24.0
12	A2005-WR12-K	PHB-12AWD打点	22.0	26.0
13	A2005-WR13-K	PHB-13AWD打点	24.0	28.0
14	A2005-WR14-K	PHB-14AWD打点	26.0	30.0
15	A2005-WR15-K	PHB-15AWD打点	28.0	32.0
16	A2005-WR16-K	PHB-16AWD打点	30.0	34.0
17	A2005-WR17-K	PHB-17AWD打点	32.0	36.0
18	A2005-WR18-K	PHB-18AWD打点	34.0	38.0

2	Wafer 针	Brass Tin 黄铜镀锡	N						
1	Housing 基座	PA66(UL94V-0)	White (白色)						
序号	图号	名称	材料	数量	附注				
未注公差		LHE ® 浙江联和电子有限公司 ZHEJIANG LIANHE ELECTRONICS CO., LTD							
X.° ±3° X.X° ±0.5°									
>0-3	>3-18	>18-50	>50-120	单位	比例	Design Units	SIZE	页码	
±0.12	±0.15	±0.3	±0.5	MM Only	—	METRIC	A4		
制作	审核	批准	材料	图号	Part No.		PHB-NAWD		
			见图解	品名					


旧底图总号
底图总号
签字
日期

PHB连接器承认图面

REV	SYM	REVISION RECORD	DR.	APPR.	DATE
A/0		原始版本			A/0
A/1		提升内针长度便于目视检测增加可靠性	YF		20221022

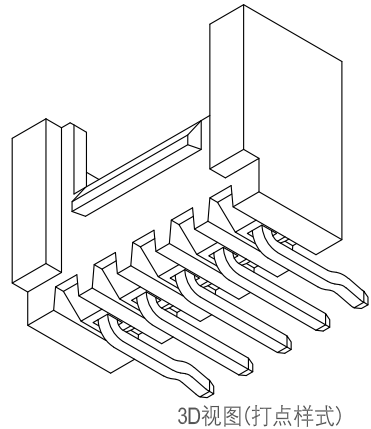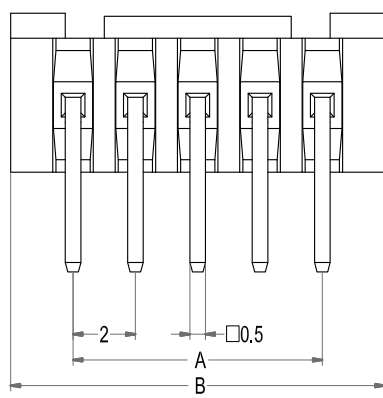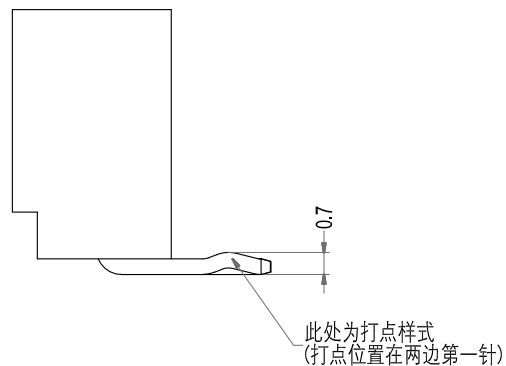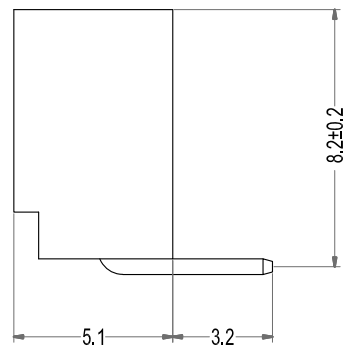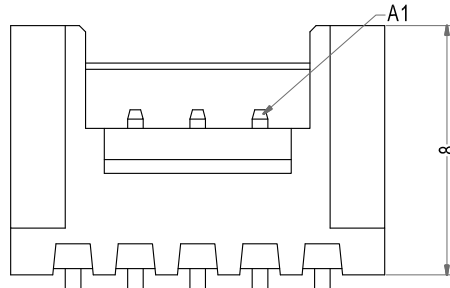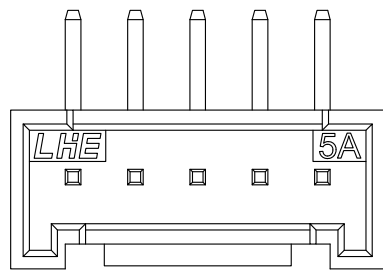

3D视图(打点样式)

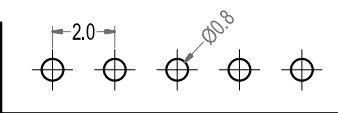

P. C. B LAYOUT







Poles	Part No.		Dimensions mm	
	A	B	A	B
2	A2005-WRB02	PHB-2AW	2.0	6.0
3	A2005-WRB03	PHB-3AW	4.0	8.0
4	A2005-WRB04	PHB-4AW	6.0	10.0
5	A2005-WRB05	PHB-5AW	8.0	12.0
6	A2005-WRB06	PHB-6AW	10.0	14.0
7	A2005-WRB07	PHB-7AW	12.0	16.0
8	A2005-WRB08	PHB-8AW	14.0	18.0
9	A2005-WRB09	PHB-9AW	16.0	20.0
10	A2005-WRB10	PHB-10AW	18.0	22.0
11	A2005-WRB11	PHB-11AW	20.0	24.0
12	A2005-WRB12	PHB-12AW	22.0	26.0
13	A2005-WRB13	PHB-13AW	24.0	28.0
14	A2005-WRB14	PHB-14AW	26.0	30.0
15	A2005-WRB15	PHB-15AW	28.0	32.0
16	A2005-WRB16	PHB-16AW	30.0	34.0
17	A2005-WRB17	PHB-17AW	32.0	36.0
18	A2005-WRB18	PHB-18AW	34.0	38.0
2	A2005-WRB02-K	PHB-2AW打点	2.0	6.0
3	A2005-WRB03-K	PHB-3AW打点	4.0	8.0
4	A2005-WRB04-K	PHB-4AW打点	6.0	10.0
5	A2005-WRB05-K	PHB-5AW打点	8.0	12.0
6	A2005-WRB06-K	PHB-6AW打点	10.0	14.0
7	A2005-WRB07-K	PHB-7AW打点	12.0	16.0
8	A2005-WRB08-K	PHB-8AW打点	14.0	18.0
9	A2005-WRB09-K	PHB-9AW打点	16.0	20.0
10	A2005-WRB10-K	PHB-10AW打点	18.0	22.0
11	A2005-WRB11-K	PHB-11AW打点	20.0	24.0
12	A2005-WRB12-K	PHB-12AW打点	22.0	26.0
13	A2005-WRB13-K	PHB-13AW打点	24.0	28.0
14	A2005-WRB14-K	PHB-14AW打点	26.0	30.0
15	A2005-WRB15-K	PHB-15AW打点	28.0	32.0
16	A2005-WRB16-K	PHB-16AW打点	30.0	34.0
17	A2005-WRB17-K	PHB-17AW打点	32.0	36.0
18	A2005-WRB18-K	PHB-18AW打点	34.0	38.0

2	Wafer 针	Brass Tin 黄铜镀锡	N						
1	Housing 基座	PA66 (UL94V-0)	1	White (白色)					
序号	图号	名称	材料	数量	附注				
未注公差		LHE ® 浙江联和电子有限公司 ZHEJIANG LIANHE ELECTRONICS CO., LTD							
X.° ±3° X.X° ±0.5°									
>0-3	>3-18	>18-50	>50-120	单位	比例	Design Units	SIZE	页码	
±0.12	±0.15	±0.3	±0.5	MM Only	—	METRIC	A4		
制作	审核	批准	材料	图号	Part No.				
			见图解	品名	PHB-NAW				

旧底图总号
底图总号
签字
日期


PHB型连接器承认图面

REV	SYM	REVISION RECORD	DR.	APPR.	DATE
A/0		原始版本			A/0
A/1	①	优化产品结构	WZY		20191223
A/2		提升内针长度便于目视检测增加可靠性	YF		20221022

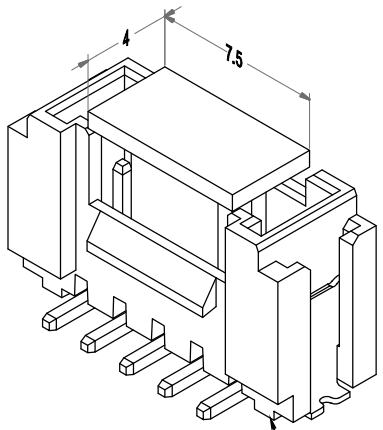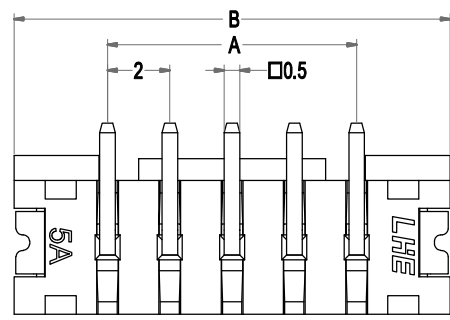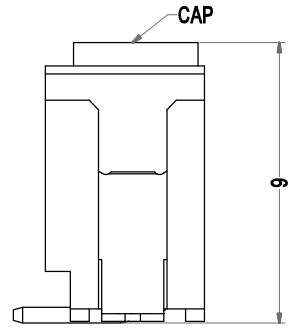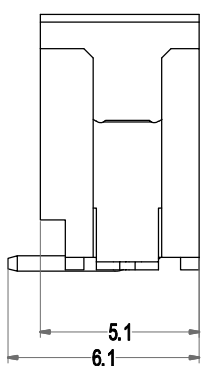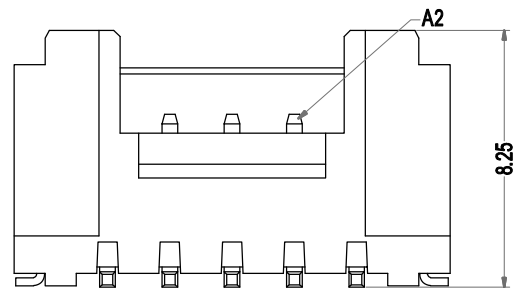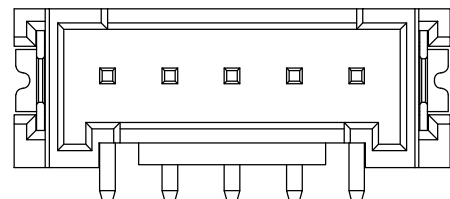

Poles	Part No.		Dimensions mm	
			A	B
2	A2005-SV02	PHB-2AB	2.0	8.0
3	A2005-SV03	PHB-3AB	4.0	10.0
4	A2005-SV04	PHB-4AB	6.0	12.0
5	A2005-SV05	PHB-5AB	8.0	14.0
6	A2005-SV06	PHB-6AB	10.0	16.0
7	A2005-SV07	PHB-7AB	12.0	18.0
8	A2005-SV08	PHB-8AB	14.0	20.0
9	A2005-SV09	PHB-9AB	16.0	22.0
10	A2005-SV10	PHB-10AB	18.0	24.0
11	A2005-SV11	PHB-11AB	20.0	26.0
12	A2005-SV12	PHB-12AB	22.0	28.0
13	A2005-SV13	PHB-13AB	24.0	30.0
14	A2005-SV14	PHB-14AB	26.0	32.0
15	A2005-SV15	PHB-15AB	28.0	34.0
16	A2005-SV16	PHB-16AB	30.0	36.0

序号	名称	材料	数量	附注
4	CAP(盖子)	LCP(UL94V-0)	1	
3	底座	LCP(UL94V-0)	1	
2	焊片	Brass/Tin 黄铜镀锡	2	
1	针脚	Brass/Tin 黄铜镀锡	N	

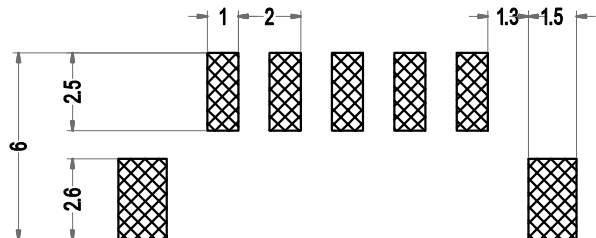









P. C. B LAYOUT

未注公差		LHE [®] 浙江联和电子有限公司			
X.° ±3° X. X° ±0.5°		ZHEJIANG LIANHE ELECTRONICS CO., LTD			
>0~3	>3~18	>18~50	>50~120	单位	比例
±0.12	±0.15	±0.3	±0.5	Design Units	SIZE
MM Only				METRIC	A4
制作	审核	批准	材料	图号	页码
见图解				品名	Part No.
PHB-NAB					

旧底图总号
底图总号
签字
日期

REV	DESCRIPTION	DATE
A/0	原始版本	E
A/1	修订版本	

PHB型连接器承认图面

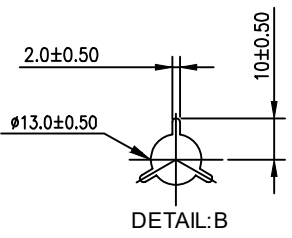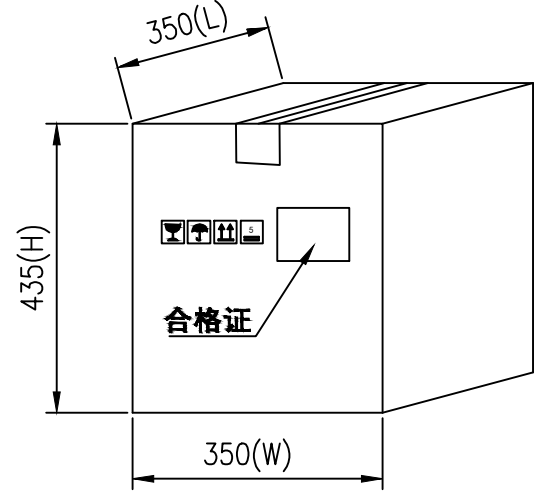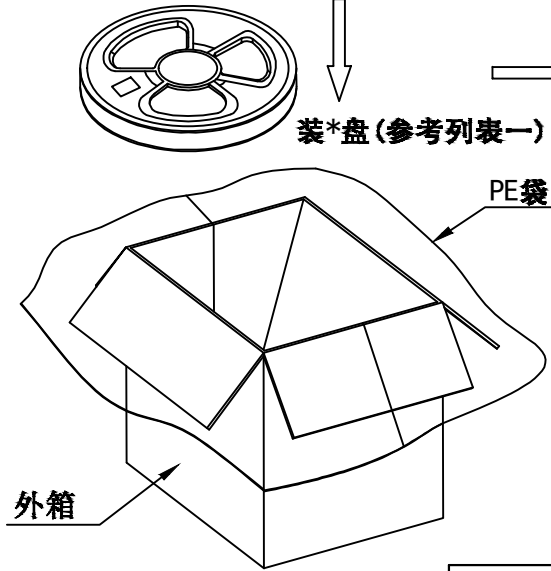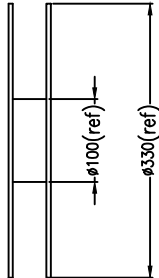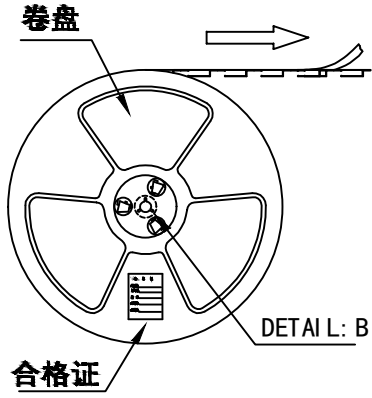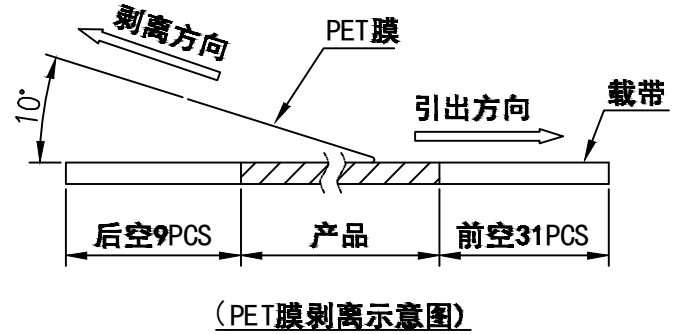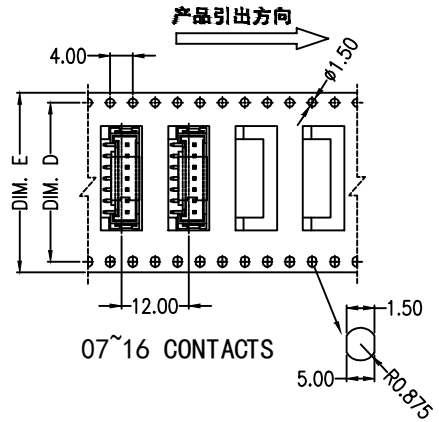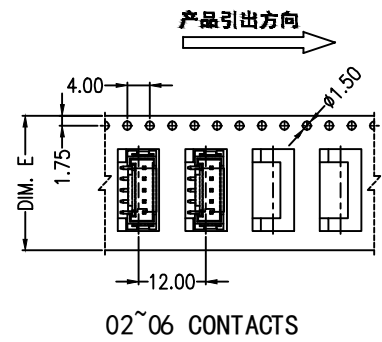

列表一

Circuits	DIM. D	DIM. E	Q'ty/Reel	Packing (Reel/Caton)
02-06PIN	-	24	600PCS	15/Reel
07-08PIN	28.4	32	600PCS	11/Reel
09~14PIN	40.4	44	600PCS	8/Reel
15~16PIN	52.4	56	600PCS	7/Reel

未注公差				LHE ® 浙江联和电子有限公司 ZHEJIANG LIANHE ELECTRONICS CO., LTD					
X.° ±3° X. X° ±0.5°				单位	比例	Design Units	SIZE	页码	
>0~3	>3~18	>18~50	>50~120	MM Only	—	METRIC	A4		
±0.12	±0.15	±0.3	±0.5	制作	审核	批准	材料	图号	Part No.
				见图解	品名	PHB-NAB盘装			

旧底图总号








底图总号

签字

日期

PHB型连接器承认图面

REV	SYM	REVISION RECORD	DR.	APPR.	DATE
A/0		原始版本			A/0
A/1	①	新模具两边增加凸台特征	WZY		20191110
A/2		提升内针长度便于目视检测增加可靠性	YF		20221022

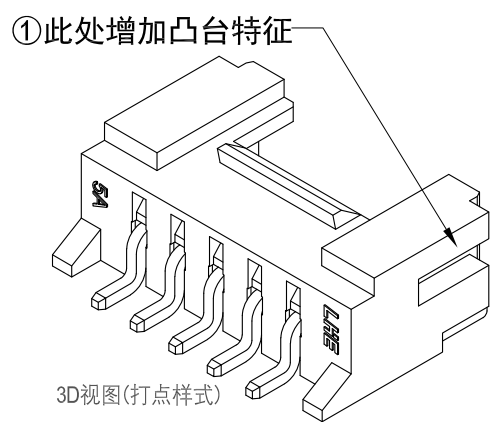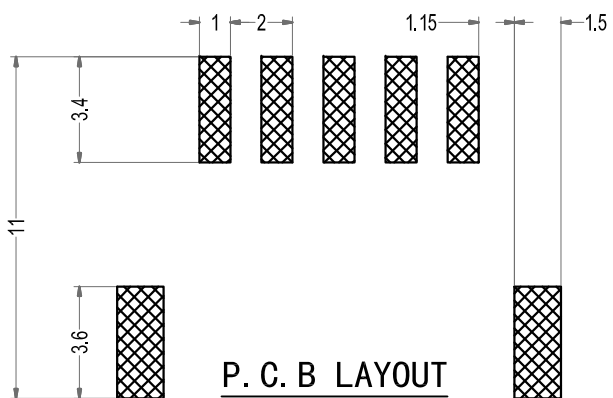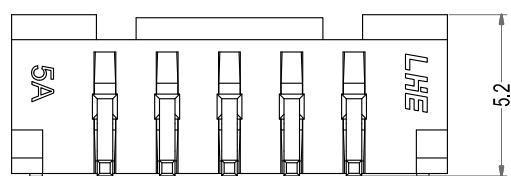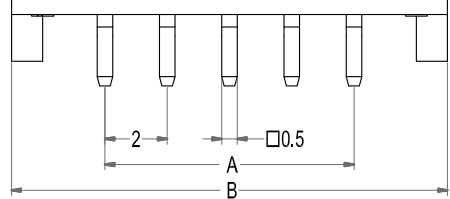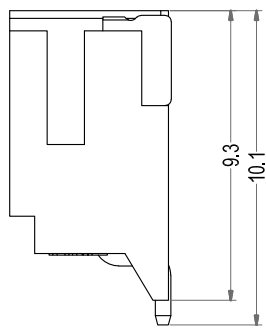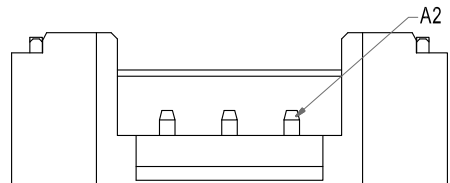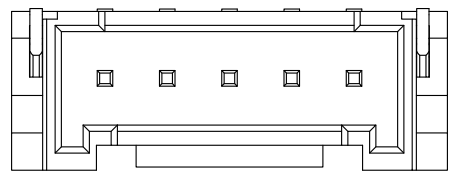


Poles	Part No.		Dimensions mm	
			A	B
2	A2005-SR02	PHB-2AWB	2.0	8.0
3	A2005-SR03	PHB-3AWB	4.0	10.0
4	A2005-SR04	PHB-4AWB	6.0	12.0
5	A2005-SR05	PHB-5AWB	8.0	14.0
6	A2005-SR06	PHB-6AWB	10.0	16.0
7	A2005-SR07	PHB-7AWB	12.0	18.0
8	A2005-SR08	PHB-8AWB	14.0	20.0
9	A2005-SR09	PHB-9AWB	16.0	22.0
10	A2005-SR10	PHB-10AWB	18.0	24.0
11	A2005-SR11	PHB-11AWB	20.0	26.0
12	A2005-SR12	PHB-12AWB	22.0	28.0
13	A2005-SR13	PHB-13AWB	24.0	30.0
14	A2005-SR14	PHB-14AWB	26.0	32.0
15	A2005-SR15	PHB-15AWB	28.0	34.0
16	A2005-SR16	PHB-16AWB	30.0	36.0

3	基座	LCP (UL94V-0)	1	
2	焊片	Brass/Tin 黄铜镀锡	2	
1	针脚	Brass/Tin 黄铜镀锡	N	
序号	名称	材料	数量	附注
未注公差		LHE ® 浙江联和电子有限公司 ZHEJIANG LIANHE ELECTRONICS CO., LTD		
X.° ±3° X. X° ±0.5°				
>0~3	>3~18	>18~50	>50~120	单位
±0.12	±0.15	±0.3	±0.5	比例
MM Only				Design Units
				SIZE
				页码
				Part No.
制作		审核		批准
材料		图号		品名
见图解		PHB-NAWB		


旧底图总号
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日期

REV	DESCRIPTION	DATE
A/0	原始版本	E
A/1	修订版本	


PHB型连接器承认图面

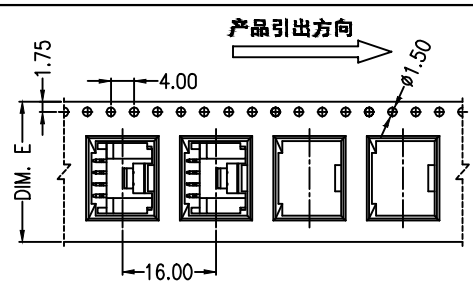


02~06 CONTACTS

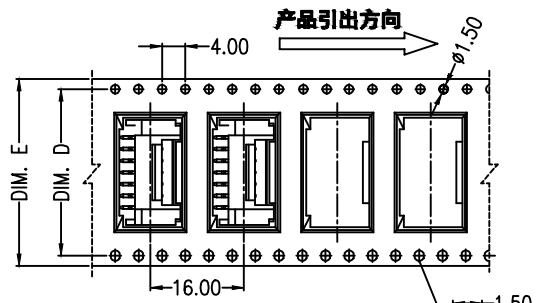

07~16 CONTACTS

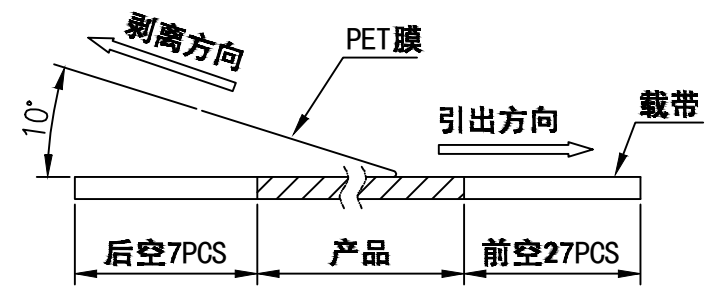


(PET膜剥离示意图)

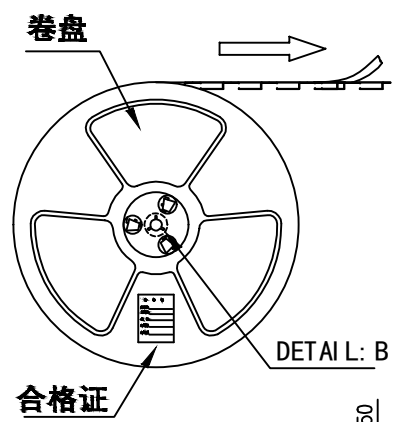


合格证


DETAIL: B

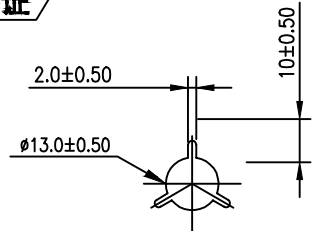


DETAIL: B

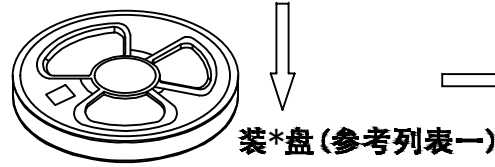

装*盘(参考列表一)

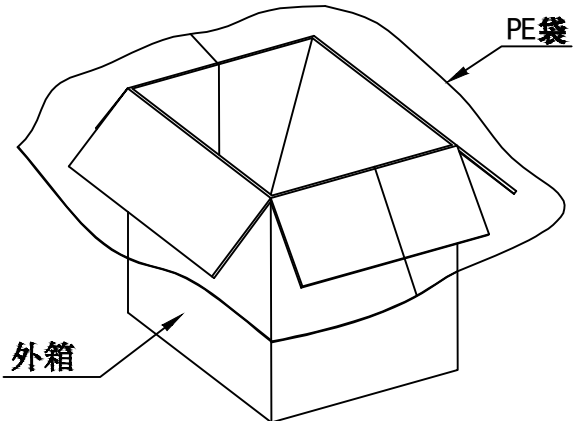

外箱

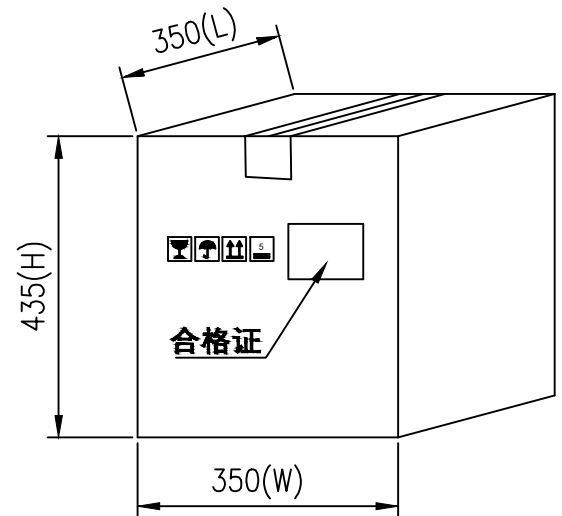

合格证

列表一

Circuits	DIM. D	DIM. E	Q'ty/Reel	Packing (Reel/Caton)
02-03PIN	-	16	800PCS	20/Reel
04-06PIN	-	24	800PCS	15/Reel
07PIN	28.4	32	800PCS	11/Reel
08-13PIN	40.4	44	800PCS	8/Reel
14-16PIN	52.4	56	800PCS	7/Reel

未注公差				LHE ® 浙江联和电子有限公司			
X.° ±3° X. X° ±0.5°				ZHEJIANG LIANHE ELECTRONICS CO., LTD			
>0~3	>3~18	>18~50	>50~120	单位	比例	Design Units	SIZE
±0.12	±0.15	±0.3	±0.5	MM Only	—	METRIC	A4
制作	审核	批准	材料	图号	Part No.		
见图解				品名	PHB-NAWB盘装		

旧底图总号
底图总号
签字
日期

产品规格书

PRODUCT SPECIFICATION

 版本号
 Version Number: B

 产品编码
 Part Number: A2005

规格 Specifications

- ◆1、极数 Poles: 2 to 16P
- ◆2、额定电流 Current rating: 3.0A AC, DC
- ◆3、额定电压 Voltage rating: 250V AC, DC
- ◆4、温度范围 Temperature range: -25°C to +105°C
- ◆5、接触电阻 Contact resistance: $\leq 30\text{m}\Omega$ (Initial)
- ◆6、绝缘电阻 Insulation resistance: $\geq 1000\text{M}\Omega$
- ◆7、耐电压 Withstand voltage: 1000V AC/minute
- ◆8、适用线规 Applicable wire: AWG #30 to #22
- ◆9、适用基板厚度 Applicable PC board thickness: 0.8mm to 1.6mm

产品性能测试 Performance test			
	项目 Item	测试条件 Test Condition	规格要求 Requirement
1	外观 Appearance	目测 Visual by eye 视力 Light: >1.0 照明 Lamp: 200~300Lx 目测距离 Space: 0.3~0.5m	1. 塑料件表面应无明显疤痕、凹陷、开裂及影响使用的变形。 Plastic part: smooth and flat surface without discolor, broken, crack distortion defects is acceptable. 2. 金属件表面无锈蚀、氧化、无明显的机械损伤等缺陷。 Metal part: tight and even surface without rust, oxide, fog and obvious physical damage defects is acceptable. 3. 导线表面清洁、无破损等缺陷, 印字及标志清晰。 Wire: clearing surface without discolor, broken defects, indistinct words and mark is acceptable.
2	接触电阻 Contact Resistance	插入连接器, 用小功率电路进行测试。 Mate connectors, measure by dry circuit.	1. 初始 (Initial) $\leq 30\text{m}\Omega$ 2. 环境测试后 (After testing) $\leq 40\text{m}\Omega$
3	绝缘电阻 Insulation Resistance	在相邻接触件之间或地线之间, 用500V DC电压进行测试。 Apply 500V DC between adjacent terminal or ground.	1000M Ω MIN
4	耐电压 Dielectric Strength	相邻接触件之间或地线之间施加50Hz 1000V AC (有效值), 漏电流1mA的电压作用, 时间1min。 Mate connectors, apply 1000V AC for 1 minute between adjacent terminal or ground.	无击穿和飞弧现象 No Breakdown

产品规格书

PRODUCT SPECIFICATION

 版本号
 Version Number: B

 产品编码
 Part Number: A2005

产品性能测试 Performance test				
	项目 Item	测试条件 Test Condition	规格要求 Requirement	
5	压着部位抗张强度 Crimping Pull Out Force	在试验装置夹头中固定测试样品，在连接的轴线方向施加张力；速度不大于25mm/min。 Fix the crimped terminal, apply axial pull out force on the wire at the speed rate of not more 25mm/min.	AWG #22 AWG #24 AWG #26 AWG #28 AWG #30	30N MIN 20N MIN 15N MIN 10N MIN 8N MIN
6	壳体/端子固定力 Terminal/Housing Retention Force	固定连接器或测力计，在连接器轴线方向施加规定的拉力；速度不大于25mm/min。 Apply axial pull out force at the speed rate of not more 25mm/min on the pin assembled in the housing.	10N MIN	
7	针的固定力 Pin Retention Force	固定连接器或测力计，在连接器轴线方向对针施加规定的推力；速度不大于25mm/min。 Apply axial push out force at the speed rate of not more 25mm/minute on the terminal assembled in the base.	10N MIN	
8	可焊性 Solderability	把测试样品需要焊接的部位浸入焊锡炉中（锡炉温度245℃±5℃）2±0.5秒钟。 Soldering time: 2±0.5 second Solder Temperature: 245℃±5℃	上锡率≥90% 90% of immersed area must show no voids, pin holes	
9	耐焊接热 Resistance to Soldering Heat	把测试样品需要焊接的部位浸入焊锡炉中（锡炉温度260℃）；2±0.5秒钟后在正常的条件下恢复1小时。 Soldering time: 2±0.5 second Solder Temperature: 260℃	外观 Appearance	无损伤 No Damage
10	耐高温 Heat Resistance	连接器配合后，于105℃±2℃的空气中放置96小时，然后再回到室温中放置1~2小时测定 Mated connectors are exposed to a temperature of 105℃±2℃ for 96 hours.	外观 Appearance 接触电阻 LLCR	无损伤 No Damage 40mΩ Max
11	耐低温 Cold Resistance	连接器配合后，于-25℃±2℃的空气中放置96小时，然后再回到室温中放置1~2小时测定 Mated connectors are exposed to a temperature of -25℃±2℃ for 96 hours.	外观 Appearance 接触电阻 LLCR	无损伤 No Damage 40mΩ Max
12	温度上升 Temperature Rise	插入连接器，通以最大允许电流。 Carrying rated current load.	温度最大上升 Temperature Rise	30℃ MAX

产品规格书

PRODUCT SPECIFICATION

版本号
Version Number: B

产品编码
Part Number: A2005

产品性能测试 Performance test				
	项目 Item	测试条件 Test Condition	规格要求 Requirement	
13	恒定湿热 Humidity	温度: 40±2℃ 相对湿度: 90%~95% 搁置时间: 96小时, 取出恢复2h后检查 Temperature: 40±2℃ Relative Humidity: 90%~95% Duration: 96 hours	外观 Appearance	无损伤 No Damage
			耐电压 Dielectric Strength	1000V, AC /minute
			绝缘电阻 Insulation Resistance	1000MΩ MIN
			接触电阻 LLGR	40mΩ MAX
14	温度循环 Temperature cycle	把测试样品放入高低温试验箱中, 按下列步骤调试温度: a) 在-25℃±2℃的恒温条件下放置0.5小时; b) 在105℃±2℃的恒温条件下放置0.5小时; 从a)到b)为一个循环周期, 共进行5个循环。 恢复1h后检查。状态转换时间不多于1小时。 Mated connectors are exposed to 5 cycles of: a) -25℃±2℃ 0.5hour b) +105℃±2℃ 0.5hour	外观 Appearance	无损伤 No Damage
			耐电压 Dielectric Strength	1000V, AC /minute
			绝缘电阻 Insulation Resistance	1000MΩ MIN
			接触电阻 LLGR	40mΩ MAX
15	机械振动 Vibration	插入连接器, 串联在一直流电源上, 电流100mA; 并模拟正常工作状态, 振频为10~55Hz、振幅1.5mm; 55~500Hz、加速度50m/s ² , 每一轴线扫频循环次数10次、2小时。 Frequency: 10~55Hz Amplitude: ±1.5mm Frequency: >55~500Hz Acceleration: 50m/s ² Duration: 2 hours in each X,Y,Z axes	外观 Appearance	无损伤 No Damage
			接触电阻 Contact Resistance	40mΩ MAX
			中断 Intermittence	1 μ sec MAX
16	机械寿命 Repeated insertion/ withdrawal	以每分钟插拔10次的速率, 插拔50次。 When mated up to 50 cycles repeatedly by the rate of 10 cycles per minute.	外观 Appearance	无损伤 No Damage
			耐电压 Dielectric Strength	1000V, AC /minute
			绝缘电阻 Insulation	100MΩ MIN
			接触电阻 Contact Resistance	40mΩ MAX

产品规格书

PRODUCT SPECIFICATION

版本号
Version Number: B

产品编码
Part Number: A2005

产品性能测试 Performance test				
	项目 Item	测试条件 Test Condition	规格要求 Requirement	
17	盐雾 Salt Spray	把先冲后镀* 的测试样品从试验箱顶悬挂下来，采用浓度为5%±1(质量百分比)的氯化钠溶液，连续雾化16小时，试验后用流动的蒸馏水轻轻洗去表面沉积物。在常温常驻湿条件下恢复1~2小时。 16 hour exposure to a saltspray from the 5%±1 solution.	外观无损伤(五金件应无露出底金属的严重锈蚀；使用预镀的型材，其落料面允许有不影响其性能的轻微腐蚀。) Appearance:No Damage (No erosion with material exposed. And with plating material, slight erosion on the cutting surface acceptable)	
18	插入力与拔出力 Insertion and Withdrawal Force	单pin相配的接触件以1mm/s~5mm/s的速度沿接插器轴线方向插入和拔出。 Insertion and withdraw connectors at the speed rate of 1mm/s~5mm/s.	插入力(最大值) Insertion (Max)	拔出力(最小值) Withdrawal (Min)
			7.5N	1.0N

* 先冲后镀为定制端子。常规端子为先镀后冲，无法通过盐雾试验。

序号	变更记录	变更原因	变更时间	责任人
1	高低温环境测试从85℃，更新到105℃	根据客户要求，进行统一的测试升级	20221022	玉夫
变更记录				

制订 Edit: _____ 审核 Check: WZY 批准 Approval: CZH 日期 Date: _____

焊接条件


Conditions for soldering

版本号
Version Number: B

产品编码
Part Number: A2005

Pb-free炉温要求 Pb-free reflow profile requirements

参数 Parameter	参考 Reference	规格 Specification
平均温度梯度预热 Average Temperature Gradient Preheating		2.5°C/s
浸泡时间 Soak time	tsoak 2-3	minutes
150°C以上时间 Time above 150°C	T1	60s
180°C以上时间 Time above 180°C	T2	50s
250°C以上时间 Time above 250°C	T3	2±0.5s
焊接温度 Peak temperature in reflow	Tpeak	255°C (-0/+5°C)
温度梯度的冷却 Temperature gradient in cooling		Max -5°C/s

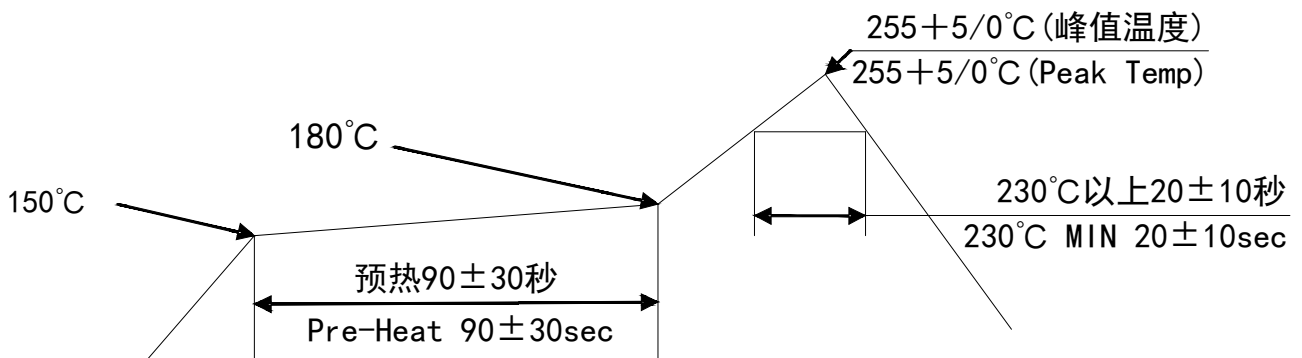

温度条件图

TEMPERATURE CONDITION GRAPH

注：该剖面的最低要求耐热性的评价焊接部件。传热方法用于回流焊热空气对流。实际的空气温度用来实现规定的轮廓，很大程度上取决于回流装置。

Note: The minimum required heat resistance of the section is to evaluate the welded components. Heat transfer method is used for hot air convection in reflow welding. The actual air temperature used to achieve the specified profile depends largely on the reflux device.



浙江联和电子有限公司

产品性能测试报告



品名 (DESCRIPTION)	PHB	测定者 (Inspector)	吴智原	测试条件 (Test Condition)	温度: 22℃ (Temperature)
料号 (MODEL NO.)	A2005	日期 (Date)	2019. 03. 23		湿度: 65% (Humidity)



试验项目 (Test Title)	规格 (Specification)		测定值(Data)					COM
			X1	X2	X3	X4	X5	
带线胶壳与针座插拔力 <带锁扣> (Connector assemble with cable and wafer, mating and unmating force with latch)	2 pin Unit: N Mating force 25 max. Unmating force 12 min.	插入(Mating)	20.5	20.0	19.5	20.5	21.5	ok
		拔出(Unmating)	25.5	26.5	22.5	24	24.5	ok
	8 pin Unit: N Mating force 70 max. Unmating force 18 min.	插入(Mating)	47.5	48	44.5	46	48.5	ok
		拔出(Unmating)	34	36	32.5	33	34.5	ok
端子和胶壳的固定力 (Terminal Retention in housing)	10N Min		27	27.5	28.0	27.5	26.0	ok
端子和插针单独插入力 (Single terminal and PIN withdrawal force)	7.5N Max		5.5	5.0	4.0	4.5	5.5	ok
端子和插针单独拔出力 (Single terminal and PIN withdrawal force)	1N Min		1.75	1.5	1.25	2.0	2.0	ok
插针和壳体的固定力 (PIN Retention in insulator)	10N Min		25	27	22	23	25	ok
盐雾试验 (Salt spray)	雾化16小时, 后镀端子不能有腐蚀现象 (Spray time:16 hours, terminals stamping then plating must not corrode)		PASS	PASS	PASS	PASS	PASS	ok
	接触电阻 (Contact Resistance)	40mΩ Max	21.7	23.2	22.4	22.9	21.5	ok
盐雾试验 (Salt spray)	雾化24小时, 插针不能有腐蚀现象 (Spray time:24 hours, PINs must not corrode)		PASS	PASS	PASS	PASS	PASS	ok
	接触电阻 (Contact Resistance)	40mΩ Max	22.1	20.5	21.8	21.9	23.5	ok
温度循环 (Temperature cycling)	外观 (Appearanc)	无损伤 (No damage)	PASS	PASS	PASS	PASS	PASS	ok
	接触电阻 (Contact Resistance)	40mΩ Max	22.8	21.9	23.4	23.9	22.4	ok
	绝缘电阻 (Insulation Resistance)	1000MΩ Min	PASS	PASS	PASS	PASS	PASS	ok
	耐电压 (Dielectric Withstanding Voltage)	1000V.AC/minute	PASS	PASS	PASS	PASS	PASS	ok

LHE 浙江联和电子有限公司

试 验 报 告


试验项目:针焰实验

试验日期: 2019/05/17

产品或零件名称	PA66 94V0 样条	生产单位	注塑
样品数量	各 3PCS	检验标准	GB/T5169.5-2008
检验设备	针焰试验箱	进货批号	/
标准要求	指 标	a. 试验样品无火焰和灼热，并且规定的铺底层或包装绢纸没有起燃 b. 在移开针焰后，试验样品和周围的零部件的火焰或灼热在 30s 之内熄灭，即 $t_b < 30s$ ，而且周围的零部件没有完全烧毁，以及规定的铺底层或包装绢纸没有起燃	
	试 验 条 件	施加试验火焰持续时间为 12s。火焰高度 12mm±1mm。	
试验结果	<div style="display: flex; justify-content: space-around;">   </div> <p>产品施焰时间 12s, 续燃时间 2.9s。无滴落物。</p>		
判定	符合要求 实验员: 唐安英 审核员: 熊英		

表单编号: QR/LHE-PZ-019

版本: B/0

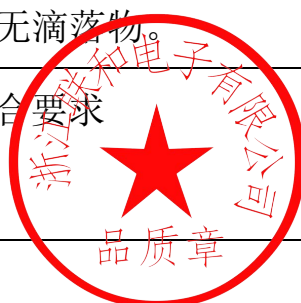

浙江联和电子有限公司

灼热丝 (GWIT/GWFI) 测试报告

序号	材料规格	试片尺寸 (长×宽×厚)	起始温度 (°C)	样品	起燃时间 (Ti)	熄灭时间 (Te)	现象记录	GWIT	GWFI
		单位: mm			单位: 秒			判定: PASS或FAIL	
1	A66V0 002	60X60X2.5	750	第1个	不起燃	/	不起燃, 无滴落	PASS (GWIT:775/2.5)	PASS (GWFI:750/2.5)
				第2个	不起燃	/	不起燃, 无滴落		
				第3个	不起燃	/	不起燃, 无滴落		
2	A66V0 002	60X60X2.5	775	第1个	不起燃	/	不起燃, 无滴落	FAIL	PASS (GWFI:775/2.5)
				第2个	不起燃	/	不起燃, 无滴落		
				第3个	8	26	接触后很快就起燃, 熔融但无滴落, 起燃后26S熄灭		
3	A66V0 002	60X60X2.5	800	第1个	6	32	接触后很快就起燃, 熔融但无滴落, 起燃后32S熄灭	FAIL	PASS (GWFI:800/2.5)
				第2个	5	31	接触后很快就起燃, 熔融但无滴落, 起燃后28S熄灭		
				第3个	6	33	接触后很快就起燃, 熔融但无滴落, 起燃后33S熄灭		

- 测试须知:
- 灼热丝起燃温度 (GWIT) 记录值为起始温度加25K (对于900°C和930°C则是30K, 960°C记为GWIT:>960/厚度);
 - 产品在移开灼热丝之后持续燃烧的时间≤30s, 即 $T_e \leq T_a$ (施加时间) +30S, 并且包装娟纸没有起燃, 则灼热丝可燃性指数 (GWFI) 即为PASS, 记录为 GWFI:温度/厚度;
 - 本实验灼热丝 T_a (施加时间) 为30S, 则 $T_e \leq 60S$
 - 如果3个其中有1个不合格则最终结果为不合格;
 - 本实验根据GB/T 5169.12-2006及GB/T 5169.13-2013执行。
 - 本实验仅针对灼热丝材料。

检测: 吴智原

确认: 陈浙海



日期: 2019-04-11

ECBT2.E364711 - Connectors for Use in Data, Signal, Control and Power Applications - Component

Connectors for Use in Data, Signal, Control and Power Applications - Component

See General Information for Connectors for Use in Data, Signal, Control and Power Applications - Component

ZHEJIANG LIANHE ELECTRONIC CO LTD

E364711

Chuangxin Road, YueQing Bay Port Zone

Yueqing, Zhejiang 325600 CHINA

Connector, Model(s) 1.58-LHE f/b 2 , f/b 1 thru 12, f/b A2 or AW., 1.58-LHE f/b 2 thru 6, f/b A2 or AW

Connector, Model(s) 1.58-LHE followed by 2, followed by 1 thru 12, followed by A(T).

Connector, Model(s) 1.58-LHE, f/b 2 thru 6 , f/b A(T), 1.58-LHE, f/b 2 thru 6, f/b Y(T), 1.58-LHE, f/b 2, f/b 1 thru 12 , f/b Y(T), 2510-LHE f/b 2 , f/b 1 thru 12, f/b A2 or AW, 2510-LHE f/b 2 thru 6, f/b A2 or AW

Connector, Model(s) 2510-LHE followed by 2, followed by 1 thru 12, followed by A(T)

Connector, Model(s) 2510-LHE, f/b 2 thru 6 , f/b A(T), 2510-LHE, f/b 2 thru 6, f/b Y(T), 2510-LHE, f/b 2, f/b 1 thru 12 , f/b Y(T), 5.08-LHE f/b 2 , f/b 1 thru 12, f/b A2 or AW, 5.08-LHE f/b 2 thru 6, f/b A2 or AW

Connector, Model(s) 5.08-LHE followed by 2, followed by 1 thru 12, followed by A(T)

Connector, Model(s) 5.08-LHE, f/b 2 thru 6 , f/b A(T), 5.08-LHE, f/b 2 thru 6, f/b Y(T), 5.08-LHE, f/b 2, f/b 1 thru 12 , f/b Y(T), 51005-LHE f/b 2 , f/b 1 thru 12, f/b A2 or AW, 51005-LHE f/b 2 thru 6, f/b A2 or AW

Connector, Model(s) 51005-LHE followed by 2, followed by 1 thru 12, followed by A(T)

Connector, Model(s) 51005-LHE, f/b 2 thru 6 , f/b A(T), 51005-LHE, f/b 2 thru 6, f/b Y(T), 51005-LHE, f/b 2, f/b 1 thru 12 , f/b Y(T), 51006-LHE f/b 2 , f/b 1 thru 12, f/b A2 or AW, 51006-LHE f/b 2 thru 6, f/b A2 or AW

Connector, Model(s) 51006-LHE followed by 2, followed by 1 thru 12, followed by A(T)

Connector, Model(s) 51006-LHE, f/b 2 thru 6 , f/b A(T), 51006-LHE, f/b 2 thru 6, f/b Y(T), 51006-LHE, f/b 2, f/b 1 thru 12 , f/b Y(T), 5102-LHE f/b 2 , f/b 1 thru 12, f/b A2 or AW, 5102-LHE f/b 2 thru 6, f/b A2 or AW

Connector, Model(s) 5102-LHE followed by 2, followed by 1 thru 12, followed by A(T)

Connector, Model(s) 5102-LHE, f/b 2 thru 6 , f/b A(T), 5102-LHE, f/b 2 thru 6, f/b Y(T), 5102-LHE, f/b 2, f/b 1 thru 12 , f/b Y(T), 5240-LHE f/b 2 , f/b 1 thru 12, f/b A2 or AW, 5240-LHE f/b 2 thru 6, f/b A2 or AW

Connector, Model(s) 5240-LHE followed by 2, followed by 1 thru 12, followed by A(T)

Connector, Model(s) 5240-LHE, f/b 2 thru 6 , f/b A(T), 5240-LHE, f/b 2 thru 6, f/b Y(T), 5240-LHE, f/b 2, f/b 1 thru 12 , f/b Y(T), 5500-LHE f/b 2 , f/b 1 thru 12, f/b A2 or AW, 5500-LHE f/b 2 thru 6, f/b A2 or AW

Connector, Model(s) 5500-LHE followed by 2, followed by 1 thru 12, followed by A(T)

Connector, Model(s) 5500-LHE, f/b 2 thru 6 , f/b A(T), 5500-LHE, f/b 2 thru 6, f/b Y(T), 5500-LHE, f/b 2, f/b 1 thru 12 , f/b Y(T), 5557 followed by 2 thru 6, followed by A(T), 5557 followed by 2 thru 6, followed by A2 or AW, 5557 followed by 2 thru 6, followed by Y(T)

Connector, Model(s) 5557 followed by 2, followed by 1 thru 12, followed by A(T).

Connector, Model(s) 5557 followed by 2, followed by 1 thru 12, followed by A2 or AW

Connector, Model(s) 5557 followed by 2, followed by 1 thru 12, followed by Y(T)

Connector, Model(s) 5559-LHE f/b 2 , f/b 1 thru 12, f/b A2 or AW, 5559-LHE f/b 2 thru 6, f/b A2 or AW

Connector, Model(s) 5559-LHE followed by 2, followed by 1 thru 12, followed by A(T).

Connector, Model(s) 5559-LHE, f/b 2 thru 6 , f/b A(T), 5559-LHE, f/b 2 thru 6, f/b Y(T), 5559-LHE, f/b 2, f/b 1 thru 12 , f/b Y(T), 5566-LHE f/b 2 , f/b 1 thru 12, f/b A2 or AW, 5566-LHE f/b 2 thru 6, f/b A2 or AW

Connector, Model(s) 5566-LHE followed by 2, followed by 1 thru 12, followed by A(T)

Connector, Model(s) 5566-LHE, f/b 2 thru 6 , f/b A(T), 5566-LHE, f/b 2 thru 6, f/b Y(T), 5566-LHE, f/b 2, f/b 1 thru 12 , f/b Y(T), 5569-LHE f/b 2 , f/b 1 thru 12, f/b A2 or AW, 5569-LHE f/b 2 thru 6, f/b A2 or AW

Connector, Model(s) 5569-LHE followed by 2, followed by 1 thru 12, followed by A(T)

Connector, Model(s) 5569-LHE, f/b 2 thru 6 , f/b A(T), 5569-LHE, f/b 2 thru 6, f/b Y(T), 5569-LHE, f/b 2, f/b 1 thru 12 , f/b Y(T), 5600-LHE f/b 2 , f/b 1 thru 12, f/b A2 or AW, 5600-LHE f/b 2 thru 6, f/b A2 or AW

Connector, Model(s) 5600-LHE followed by 2, followed by 1 thru 12, followed by A(T)

Connector, Model(s) 5600-LHE, f/b 2 thru 6 , f/b A(T), 5600-LHE, f/b 2 thru 6, f/b Y(T), 5600-LHE, f/b 2, f/b 1 thru 12 , f/b Y(T), 63080-LHE f/b 2 , f/b 1 thru 12, f/b A2 or AW, 63080-LHE f/b 2 thru 6, f/b A2 or AW

Connector, Model(s) 63080-LHE followed by 2, followed by 1 thru 12, followed by A(T)

Connector, Model(s) 63080-LHE, f/b 2 thru 6 , f/b A(T), 63080-LHE, f/b 2 thru 6, f/b Y(T), 63080-LHE, f/b 2, f/b 1 thru 12 , f/b Y (T), B2502 followed by 2 thru 16, followed by Y(T), BH3.5-2A(T), BH3.5-2Y(T), MX3.0 followed by 2 thru 12, followed by A(T), MX3.0 followed by 2 thru 12, followed by A2 or AW, MX3.0 followed by 2 thru 12, followed by Y(T)

Connector, Model(s) MX3.0 followed by 2, followed by 1 thru 12, followed by A(T).

Connector, Model(s) MX3.0 followed by 2, followed by 1 thru 12, followed by A2 or AW

Connector, Model(s) MX3.0 followed by 2, followed by 1 thru 12, followed by Y(T)

Connector, Model(s) PA-LHE f/b 2, f/b 1 thru 12, f/b Y(T), PA-LHE followed by 2 thru 12, followed by A(T)

Connector, Model(s) PA-LHE followed by 2 thru 12, followed by A2 or AW

Connector, Model(s) PA-LHE followed by 2 thru 12, followed by Y(T)

Connector, Model(s) PA-LHE followed by 2, followed by 1 thru 12, followed by A(T)

Connector, Model(s) PA-LHE followed by 2, followed by 1 thru 12, followed by A2 or AW

Connector, Model(s) PH, PHB, XHB, JC25, SCN followed by -2 thru -20, followed by Y(T), A, AW or AWD

Connector, Model(s) PHB followed by 2 thru 16, followed by Y(T). followed by 2 thru 16, followed by AWD, A, AW

Connector, Model(s) Series 1.25, 1254, 1255 followed by -2 thru -25, followed by Y(T), A or AW

Connector, Model(s) Series 5264 followed by -2 thru -16, followed by Y(T), A or AWD

Connector, Model(s) SM followed by -2 thru -18, followed by Y(T) or A(T)

Connector, Model(s) VH, 3.96 followed by -2 thru -16, followed by Y(T), A, AW or AWG

Connector, Model(s) XA-LHE f/b 2, f/b 1 thru 12, f/b Y(T), XA-LHE followed by 2 thru 12, followed by A(T)

Connector, Model(s) XA-LHE followed by 2 thru 12, followed by A2 or AW

Connector, Model(s) XA-LHE followed by 2 thru 12, followed by Y(T)

Connector, Model(s) XA-LHE followed by 2, followed by 1 thru 12, followed by A(T)

Connector, Model(s) XA-LHE followed by 2, followed by 1 thru 12, followed by A2 or AW

Connector, Model(s) XH followed by -2 thru -20, followed by Y(T), A, AW, AWGD, AWD or AWGDJ

Connector, Model(s) ZH followed by 2 thru 16, followed by AWD or A, ZH followed by 2 thru 16, followed by Y(T).

Model(s) 1.25, followed by -2 thru -16, followed by AB or AWB

Model(s) 51146 or FI-S, followed by -2 thru -16, followed by AB or AWB

Model(s) A5001, followed by -2 thru -7, followed by Y, Y(T), AD or AWD

Model(s) B2501-LHE, A2004-LHE, A4203-LHE, PHR-LHE, PHD-LHE, CH2.5-LHE, DF11-LHE, PHSD-LHE, A5001-LHE, 35155-LHE, 35156-LHE, 5195-LHE, 5196-LHE, followed by 2 thru 16, followed by Y(T)

Model(s) BHS-LHE, SMH250-LHE, SMH200-LHE, L6.2-LHE, 1806-LHE, 2060-LHE, 2541-LHE, JC15-LHE, XHD-LHE, followed by -2, followed by A(T), or Y(T)

Model(s) JWPF-LHE, B2541-LHE, NV-LHE, DV-LHE, SGN-LHE, SJN-LHE, SDN-LHE, SIN-LHE, 35150-LHE, 35151-LHE, 35180-LHE, 35182-LHE, 35524-LHE, 35965-LHE, RCY-LHE, LC-LHE, VR-LHE, SHJ-LHE, SHL-LHE, DF19-LHE, ACH-LHE, DF13-LHE, IL-Z-LHE, 51146-LHE, SATA-LHE, XSR-LHE, SUR-LHE, SUH-LHE, ZE-LHE, ZND-LHE, ZPD-LHE, A1502-LHE, SFH-LHE, 51004-LHE, PUD-LHE, A20010-LHE, 35507-LHE, DF3-LHE, PND-LHE, RE-LHE, RA-LHE, RF-LHE or A3963, followed by -2 thru -15, followed by Y(T), YB(T) or YC(T), A, A-K, AW, AW-K, AD, AD-K, AWGD, AWGD-K, AQ, AQ-K, AWQ, AWQ-K, AD(BH) or AD(BH)-K.

Model(s) PH, followed by -2 thru -16, followed by AB or AWB

Model(s) PHB, SZN-LHE, SAN-LHE, JC20-LHE, EH-LHE, EI-LHE, EL-LHE, S-EL-LHE, followed by 2 thru 16, followed by AWD, A, AW

Model(s) PHB, SZN-LHE, SAN-LHE, JC20-LHE, EH-LHE, EI-LHE, EL-LHE, S-EL-LHE, followed by 2 thru 16, followed by Y(T)

Model(s) PHB, XH, XHB or XHBD, followed by -2 thru -16, followed by AB or AWB.

Model(s) RAST 5-LHE TAB HEADER ASSY , TH, Vertical, Cat. Nos. 1969738-LHE, 1969740-LHE, 1971845-LHE, 1971846-LHE, 1971895-LHE, 1971896-LHE, 1971946-LHE thru 1971949-LHE, 1971954-LHE thru 1971957-LHE, 2232008-LHE thru 2232011-LHE, 2232000-LHE thru 2232003-LHE, 2232016-LHE thru 2232019-LHE, 1971962-LHE thru 1971965-LHE, 2232024-LHE thru 2232027-LHE, 2232289-LHE thru 2232292-LHE, 2232043-LHE thru 2232074-LHE, 2232298-LHE thru 2232301-LHE, 2232511-LHE, 2232532-LHE, 2232557-LHE, 2232559-LHE, 2232560-LHE, 2232562-LHE, 2232563-LHE, 2232565-LHE, 2232566-LHE, 2232568-LHE, 2232569-LHE, 2232571-LHE, 2232572-LHE, 2232574-LHE, 2232575-LHE, 2232577-LHE, 2232578-LHE, 2232580-LHE, 2232581-LHE, 2232583-LHE, 2232584-LHE, 2232586-LHE, 2232587-LHE, 2232589-LHE, 2232590-LHE, 2232592-LHE, 2232593-LHE, 2232595-LHE, 2232596-LHE, 2232598-LHE, 2232599-LHE, 2232601-LHE, 2232602-LHE, 2232604-LHE, 2232605-LHE, 2232607-LHE, 2232608-LHE, 2232611-LHE thru 2232682-LHE, 2292457-LHE, 2292458-LHE, may incorporate prefix and/or suffix number.), followed by -2 thru -7, followed by Y, Y(T), AD or AWD.

Model(s) SY, followed by -2, followed by Y, Y(T), A or A(T)

Model(s) SYP, SYR, BH4.0-LHE, A10001-LHE, A7501-LHE, A8001-LHE, C2541-LHE, C2542-LHE, D250R-LHE, D280K-LHE, D300R-LHE, D350R-LHE, D400B-LHE, D430R-LHE, D470G-LHE, D480J-LHE, D480K-LHE, D480N-LHE, D480Q-LHE, D520H-LHE, D520K-LHE, D520Q-LHE, D620G-LHE, D630J-LHE, D630N-LHE, D630Q-LHE, D700G-LHE, F001-LHE, F002-LHE, HIF3-LHE, MC100-LHE, MC100-LHE, ME020-LHE, ME010-LHE, F2541-LHE, D2301-LHE, 1719057-LHE, 1719059-1-LHE, P0011-LHE, P0012-LHE, P0013-LHE, C6001-LHE, D2201-LHE, D2202-LHE or P0001-LHE, followed by -2, followed by Y, Y(T), A or A(T).

Model(s) VL-LHE , YL-LHE, SL-LHE, FL-LHE, YHD200-LHE, HA-LHE, LGC-LHE, JR-LHE, SP-LHE, 5025-LHE, followed by 2, followed by 1 thru 12, followed by A(T), Y(T), A2 or AW



Model(s) VL-LHE, YL-LHE, SL-LHE, FL-LHE, YHD200-LHE, HA-LHE, LGC-LHE, JR-LHE, SP-LHE, 5025-LHE, followed by 2 thru 12, followed by A(T), Y(T), A2 or AW

Model(s) XHD, XHE or XHQ, followed by -2 thru -15, followed by Y(T), YB(T) or YC(T), A, A-K, AW, AW-K, AD, AD-K, AWGD, AWGD-K, AQ, AQ-K, AWQ, AWQ-K, AD(BH) or AD(BH)-K.

Model(s) ZH, followed by -2 thru -16, followed by AB or AWB

Model(s) ZHR-LHE, SH-LHE, GH-LHE, NH-LHE, C1251-LHE, DF14-LHE, 5501-LHE, 75416-LHE, 543-LHE, followed by 2 thru 16, followed by AWD or A

Model(s) ZHR-LHE, SH-LHE, GH-LHE, NH-LHE, C1251-LHE, DF14-LHE, 5501-LHE, 75416-LHE, 543-LHE, followed by 2 thru 16, followed by Y(T)

Marking: Company name or trademark  , model designation and the Recognized Component Mark,  on the device or carton.

Last Updated on 2020-02-20

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Certificate of Registration

This certifies that the Quality Management System of

Zhejiang Lianhe Electronics Co., Ltd.

Leshang Pioneer Park, Yueqingwan Area,
Yueqing City, Zhejiang Province, China 325600

Has been assessed by NSF-ISR and found to be in conformance to the following standards(s):

IATF 16949:2016

Scope of Registration:

Design and Manufacturing of Connector



IATF Certificate Number:	0356219
Certificate Number:	CNIATF038887
Certificate Issue Date:	28-JUN-2019
Registration Date:	26-JUN-2019
Expiration Date*:	25-JUN-2022

Tom Chestnut,
Sr Vice President - ISR,
NSF-ISR, Ltd.

NSF International Strategic Registrations

789 North Dixboro Road, Ann Arbor, Michigan 48105 | (888) NSF-9000 | www.nsf-isr.org

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产品认证证书

证书编号: CQC17134174484

申请人名称及地址

浙江联和电子有限公司
浙江省乐清市乐清湾港区乐商创业园

制造商名称及地址

浙江联和电子有限公司
浙江省乐清市乐清湾港区乐商创业园

生产企业名称及地址

浙江联和电子有限公司 (V028069)
浙江省乐清市乐清湾港区创新路 8 号

产品名称和系列、规格、型号

连接器聚酰胺 66 (PA66)

型号见附件, 材料名称: 聚酰胺 (PA66), 材料牌号: A3RV0, 全色, 球压: 200°C, 灼热丝可燃性指数 (GWFI): 960/0.3, 灼热丝起燃温度 (GWIT): 960/0.3, 燃烧等级: V-0@0.3mm, CTI600, 红外光谱, 差示扫描量热和热重分析见报告 00601-2019134003025

产品标准和技术要求

GB/T 5169.21-2017, GB/T 5169.12-2013, GB/T 5169.13-2013, GB/T 5169.16-2017, GB/T 4207-2012, GB/T 6040-2002, GB/T 19466.1-2004, GB/T 19466.2-2004, GB/T 19466.3-2004, ISO 11358-1:2014

认证模式

产品检测+获证后监督

上述产品符合 CQC13-036047-2009 认证规则的要求, 特发此证。

发证日期: 2019 年 09 月 29 日

本证书的有效性依据发证机构的定期监督获得保持。
本证书为变更证书, 证书首次颁发日期: 2017 年 07 月 27 日

主任: _____



中国质量认证中心

中国·北京·南四环西路 188 号 9 区 100070

<http://www.cqc.com.cn>

VERIFICATION OF LVD COMPLIANCE

Applicant: Zhejiang Lianhe Electrical Co., Ltd.
 Houyu village, Shifan town, Yueqing city, Zhejiang province, China.

Manufacturer: Same as applicant

Product Description: Connector Terminal

Model No: A1001, A1002, A1003, A1251, A1252, A1253, A1254, A1255, A1256, A1257, A1501, A1502, A1503, A2001, A2002, A2003, A2004, A2005, A2006, A2007, A2501, A2502, A2503, A2504, A2505, A2506, A2507, A2541, A2542, A2543, A2544, A2545, A3961, A3962, A3963, A3564, A5081, A5082, B1501, B1502, B2001, B2002, B2501, B2502, C01581, C01582, C1251, C2001, C2002, C2501, C2502, C2505, C2506, C3001, C3002, C3003, C3004, C3005, C3006, C3501, C3502, C3701, C3702, C4001, C4002, C4141, C4142, C4201, C4202, C4203, C4204, C4601, C4602, C4501, C4502, C4503, C4504, C5001, C5002, C5031, C5032, C6201, C6202, C6351, C6352, C6701, C6702, D2801, D2802, D2803, D4801, D4802, D4803, D4804, D6301, D6302, D6303

Sufficient samples of the product have been tested and found to be in conformity with


Test Standard: EN 60320-1:2001/A1:2007
EN 60529:1991/A1:2000

As shown in the
 Test Report Number(s): TLZJ1411264692
 Date of issue: November 27, 2014

Conclusion

This Verification of LVD Compliance has been granted to the applicant based on the results of tests, performed by laboratory of Global Testing Services Co., Ltd on sample of the above-mentioned product in accordance with the provisions of the relevant specific standards and the Low Voltage Directive 2014/35/EU. The CE marking as shown below can be affixed, under the responsibility of the manufacturer, after completion of an EC Declaration of Conformity and compliance with all relevant EC Directives. The affixing of the CE marking presumes in addition that conditions the conditions in annexes III and IV of the Directive are fulfilled.

Approved by: Hermann Weiher

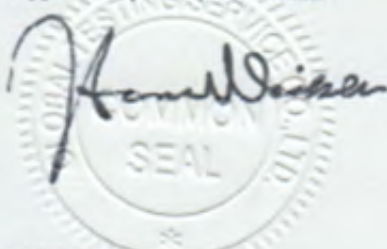

For and on behalf of
 Global Testing Services Co., Ltd



Global Testing Services Co., Ltd
 E-mail: info@gts-lab.com http://www.gts-lab.com
 Room 1501-1502, No. 520 Yishan Rd., Xuhui District, Shanghai, 200235 China

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ZERTIFIKAT ■ CERTIFICATE ■ CERTIFICADO ■ CERTIFICAT



QUALITY MANAGEMENT SYSTEM CERTIFICATE

Certificate No. 00117Q310977R2S/3302

We hereby certify that

Zhejiang LianHe Electronics Co., Ltd.

Unified Social Credit Code/ Organization Code certificate: 913303825540033504

Registration Address: Houyu Village, Shifan Town, Yueqing City, Wenzhou City, Zhejiang Province, China

Production Address: Yueshang Pioneer Park, Yueqing Bay Port Area, Yueqing City, Wenzhou City, Zhejiang Province China

by reason of its
Quality Management System
has been awarded this certificate for compliance with the standard
GB/T 19001-2016 / ISO 9001:2015

The Quality Management System Applies in the following area:

The Design, Production of Electronics Connector

Certified since: February 13, 2012 Valid from: December 11, 2017 Valid until: December 14, 2020


After a surveillance cycle, the certificate is valid only when used together with an Acceptance Notice of Surveillance Audit issued by CQC.
Please access www.cqc.com.cn for checking validity of the certificate.

This certificate and its relevant information can query in the website of Certification and Accreditation Administration of the People's Republic of China (www.cnca.gov.cn).



中国认可
国际互认
管理体系
MANAGEMENT SYSTEM
CNAS C001-M


Signed by: Wang Kejian

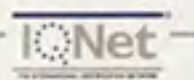

CHINA QUALITY CERTIFICATION CENTRE

Section 9, No.188, Nansihuan(the South Fourth Ring Road) Xilu(West Road), Beijing 100070,China
<http://www.cqc.com.cn>



THE INTERNATIONAL CERTIFICATION NETWORK

CERTIFICATE

IQNet and
CQC

hereby certify that the organization

Zhejiang LianHe Electronics Co., Ltd.

Registration Address: Houyu Village, Shifan Town, Yueqing City, Wenzhou City, Zhejiang Province, China
Production Address: Yueshang Pioneer Park, Yueqing Bay Port Area, Yueqing City, Wenzhou City, Zhejiang Province China

For the following field of activities

The Design, Production of Electronics Connector

Has implemented and maintains a
Management System


Which fulfils the requirements of the following standard

GB/T 19001-2016 / ISO 9001:2015

Issued on: December 11, 2017

Validity date: December 14, 2020

Registration Number: 00117Q310977R2S/3302

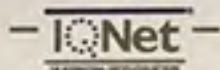

Michael Drechsel
President of IQNet

Wang Kejiao
President of CQC



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SQS Switzerland SRAC Romania TEST St Petersburg Russia TSE Turkey YUQS Serbia
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* The list of IQNet partners is valid at the time of issue of this certificate. Updated information is available under www.iqnet-certification.com

检测报告

编号: NGBEC2200627404

日期: 2022年04月20日

第1页,共11页

客户名称: 浙江联和电子有限公司
客户地址: 浙江省乐清市乐清湾港区乐商创业园

样品名称: PA66 连接器
型号: XHD-5A
客户参考信息: 见附件
以上样品及信息由客户提供。

SGS工作编号: NP22-001796 - NB
样品接收日期: 2022年04月08日
检测周期: 2022年04月08日 - 2022年04月20日
检测要求: 根据客户要求检测
检测方法: 请参见下一页
检测结果: 请参见下一页
结论: 基于所送样品002的指定部位进行的检测, 镉、铅、汞、六价格的检测结果符合欧盟RoHS指令2011/65/EU附录II的修正指令(EU) 2015/863的限值要求。

基于所送样品001的指定部位进行的检测, 镉、铅、汞、六价铬、多溴联苯(PBBs)、多溴二苯醚(PBDEs)、邻苯二甲酸酯(如邻苯二甲酸二丁酯(DBP)、邻苯二甲酸丁苄酯(BBP)、邻苯二甲酸二(2-乙基己基)酯(DEHP)和邻苯二甲酸二异丁酯(DIBP))的检测结果符合欧盟RoHS指令2011/65/EU附录II的修正指令(EU) 2015/863的限值要求。

通标标准技术服务有限公司宁波分公司
授权签名

张倩倩

Ashley Zhang 张倩倩
批准签署人



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检测报告

编号: NGBEC2200627404

日期: 2022年04月20日

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检测结果:

检测样品描述:

样品编号	SGS样品ID	描述
SN1	NGB22-006274.001	白色塑料部分
SN2	NGB22-006274.002	银色金属部分

备注:

- (1) 1 mg/kg = 0.0001%
- (2) MDL = 方法检测限
- (3) ND = 未检出 (< MDL)
- (4) "-" = 未规定

RoHS指令2011/65/EU附录II的修正指令(EU) 2015/863

检测方法: 参考IEC 62321-4:2013+AMD1:2017, IEC 62321-5:2013, IEC 62321-7-2:2017, IEC 62321-6:2015和IEC 62321-8:2017, 采用ICP-OES,UV-Vis和GC-MS进行分析。

检测项目	限值	单位	MDL	001
镉(Cd)	100	mg/kg	2	ND
铅(Pb)	1000	mg/kg	2	ND
汞(Hg)	1000	mg/kg	2	ND
六价铬 (Cr(VI))	1000	mg/kg	8	ND
多溴联苯(PBBs)之和	1000	mg/kg	-	ND
一溴联苯	-	mg/kg	5	ND
二溴联苯	-	mg/kg	5	ND
三溴联苯	-	mg/kg	5	ND
四溴联苯	-	mg/kg	5	ND
五溴联苯	-	mg/kg	5	ND
六溴联苯	-	mg/kg	5	ND
七溴联苯	-	mg/kg	5	ND
八溴联苯	-	mg/kg	5	ND
九溴联苯	-	mg/kg	5	ND
十溴联苯	-	mg/kg	5	ND
多溴二苯醚之和(PBDEs)	1000	mg/kg	-	ND
一溴二苯醚	-	mg/kg	5	ND
二溴二苯醚	-	mg/kg	5	ND
三溴二苯醚	-	mg/kg	5	ND
四溴二苯醚	-	mg/kg	5	ND
五溴二苯醚	-	mg/kg	5	ND



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SGS-CSL Standards Technical Services Co., Ltd.
Ningbo Branch Laboratory

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中国·浙江·宁波高新区凌云路1177号 邮编: 315040 tHL (86-574)89070271 tML (86-574)89070242 sgs.china@sgs.com

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检测报告

编号: NGBEC2200627404

日期: 2022年04月20日

第3页,共11页

检测项目	限值	单位	MDL	001
六溴二苯醚	-	mg/kg	5	ND
七溴二苯醚	-	mg/kg	5	ND
八溴二苯醚	-	mg/kg	5	ND
九溴二苯醚	-	mg/kg	5	ND
十溴二苯醚	-	mg/kg	5	ND
邻苯二甲酸二丁酯 (DBP)	1000	mg/kg	50	ND
邻苯二甲酸丁苯酯(BBP)	1000	mg/kg	50	ND
邻苯二甲酸二(2-乙基己基)酯(DEHP)	1000	mg/kg	50	ND
邻苯二甲酸二异丁酯(DIBP)	1000	mg/kg	50	ND

备注:

- (1) 最大允许极限值引用自RoHS指令(EU) 2015/863。
- (2) IEC 62321 系列等同于 EN 62321 系列
https://www.cenelec.eu/dyn/www/f?p=104:30:1742232870351101:::FSP_ORG_ID,FSP_LANG_ID:1258637,25。
- (3) 2021年7月22号开始, DEHP, BBP, DBP 和 DIBP的限制适用于医疗器械, 包括体外医疗器械, 监控仪表, 包括工业监测和控制仪器。

RoHS指令2011/65/EU附录II的修正指令(EU) 2015/863

检测方法: 参考IEC 62321-4:2013+AMD1:2017, IEC 62321-5:2013 和 IEC 62321-7-1:2015, 采用ICP-OES和UV-Vis 进行分析。

检测项目	限值	单位	MDL	002
镉 (Cd)	100	mg/kg	2	ND
铅(Pb)	1000	mg/kg	2	ND
汞 (Hg)	1000	mg/kg	2	ND
六价铬(Cr(VI))▼	-	µg/cm ²	0.10	ND

备注:

- (1) 最大允许极限值引用自RoHS指令(EU) 2015/863。
- (2) IEC 62321 系列等同于 EN 62321 系列
https://www.cenelec.eu/dyn/www/f?p=104:30:1742232870351101:::FSP_ORG_ID,FSP_LANG_ID:1258637,25。
- (3) ▼ = a. 当六价铬的浓度高于0.13 µg/cm²时, 样品为阳性, 即含有六价铬;
 b. 当六价铬的浓度为ND(低于0.10 µg/cm²)时, 样品为阴性, 即未检测到六价铬;
 c. 当六价铬的浓度介于0.10 µg/cm²与0.13 µg/cm²之间时, 无法直接判定是否检测到六价铬, 因不同个体的样品表面差异可能会影响测定结果;
 由于未获知样品的存储条件和生产日期, 样品的六价铬测试结果仅能代表测试时样品含六价铬的状态。



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检测报告

编号: NGBEC2200627404

日期: 2022年04月20日

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附件:

XH, 1.0, SH, SHD, 1.25, 51021, DF14, DF13, GH, ZH, PH, PHB, PA, PHSD, DF11, C1251, 51047, 51146, FI-S, PHD, YHD200, PA, SMP, SMW, SMH, SMH200, SMH200-H, YH200, 20039WR, 杜邦2.0, XH/TJC3, XA, HA, XHB, XHD, XHE, EH, EI, 小四P, 5263, 5264, 5267, 5268, SZN, SAN, SCN, SCND, JC15, JC20, JC25, 5102, 5240, SMH250, SMP250, SMW250, 25048HS, 25045HP, SM, TJC8, 杜邦2.54, TJC8A, 杜邦带锁, TJC8B, TJC8H, 5051, 2510, 美尚美, 43640, 43645, 43020, 43025, 5500, 5600, VH, VHRR, YH396, VHR, 35156, 2139, 3.96, 90331, 5195, 5196, 39612, FL, 5557, 5559, 5566, 5569, SL, RV42, EL, YL, 小EL, 8981, 大四P, 5058, 5.08, L6.2, VL, VLP/VLR, TJC2, TJC2A, TJC2B, TJC4, TJC1, 1806, MX3.0, 1.58, 51005, 51006, BH3.5, BH4.0, 63080, 51004, TJC15, A4203, CL014, OTP, MKH, SMF, Cy-X201, 35108, 35150, 35151, 35224, 35180, 35965, 42021, 42022, 42002, 35955, SA, SCS, 35189, 35196, CH10, CH2.5, 543, SLP, SLR, YHL500, YWL500, FFC, FPC, 20030, 250, LGC, S11, YH025, 35155, 25415, 5197, 5198, 110, 2.8, 6.3, SCS

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检测报告

编号: NGBEC2200627404

日期: 2022年04月20日

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 D2201 D2202 D2203 D2204 D2205 D2206 D2207 D2208 D2209



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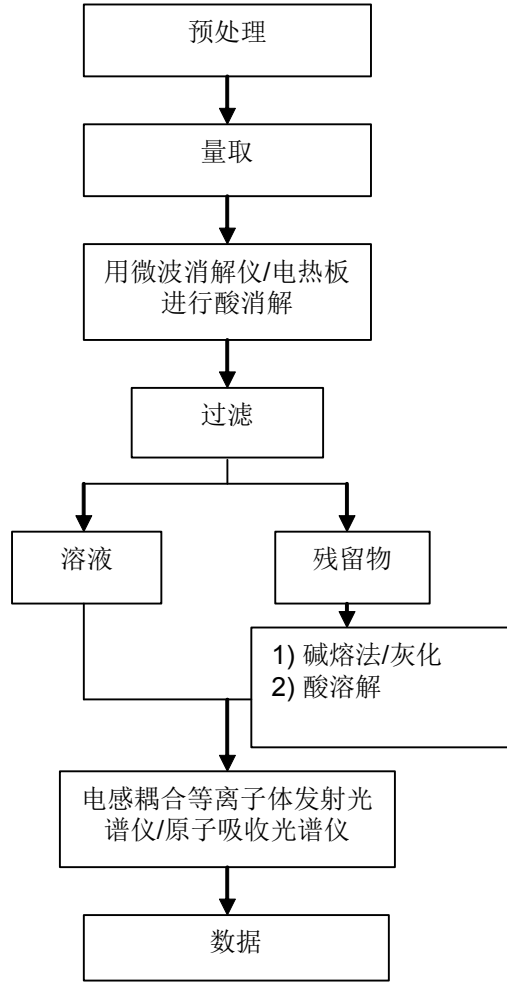
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 Ningbo Branch Chemical Laboratory

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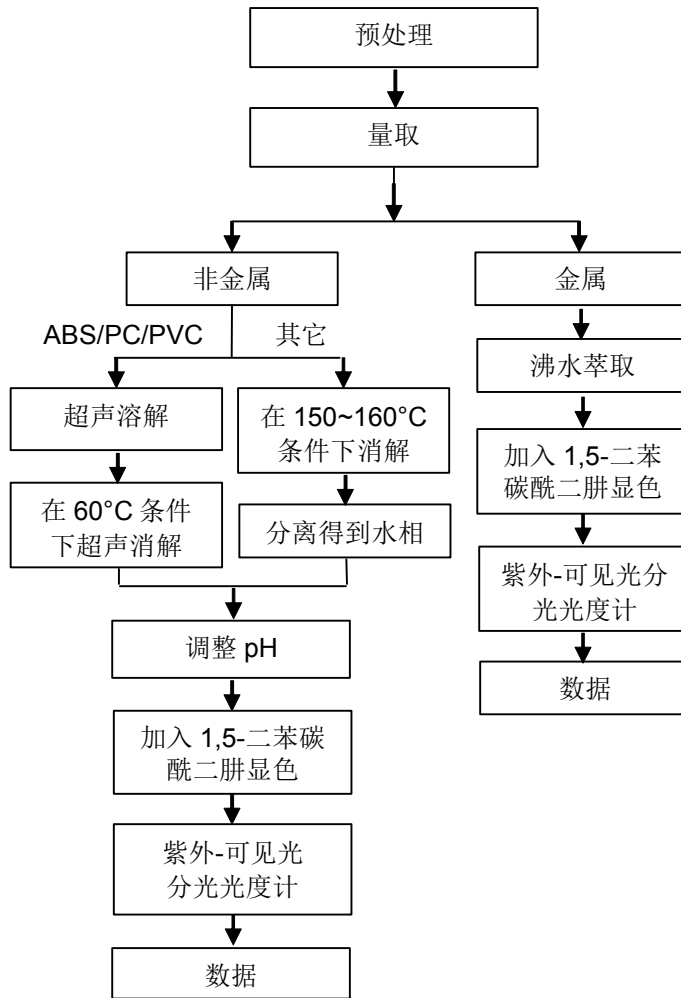
元素(IEC62321) 测试流程图

1)样品按照下述流程被完全消解




附件

六价铬测试流程图




PBBs/PBDEs 测试流程图

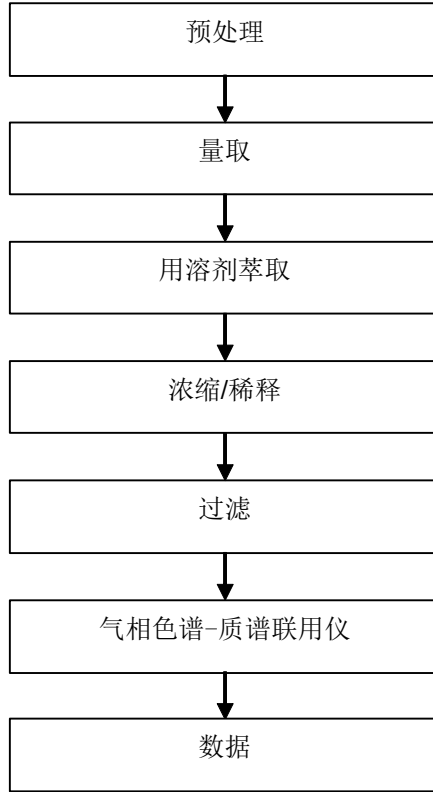

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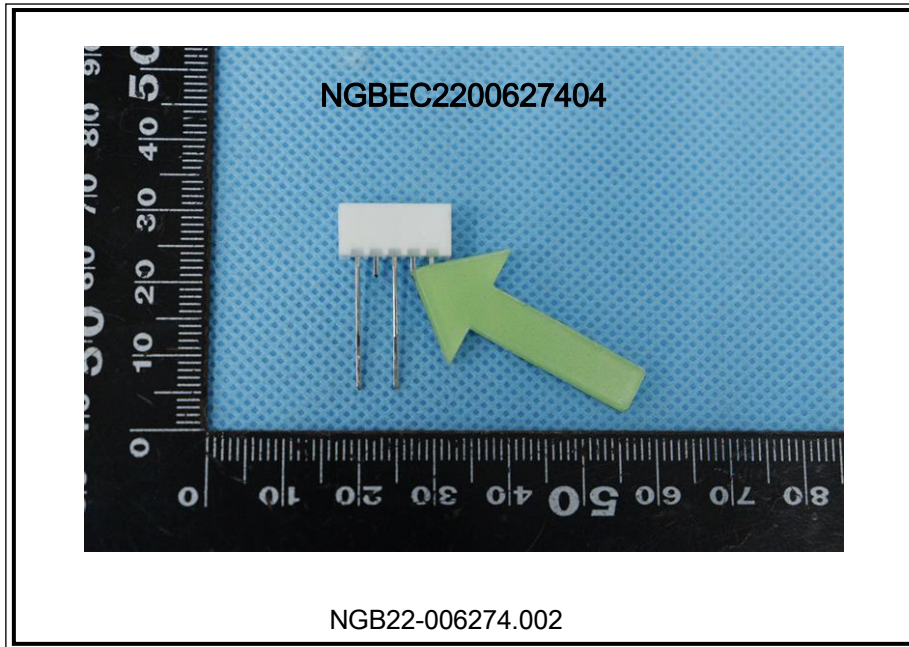
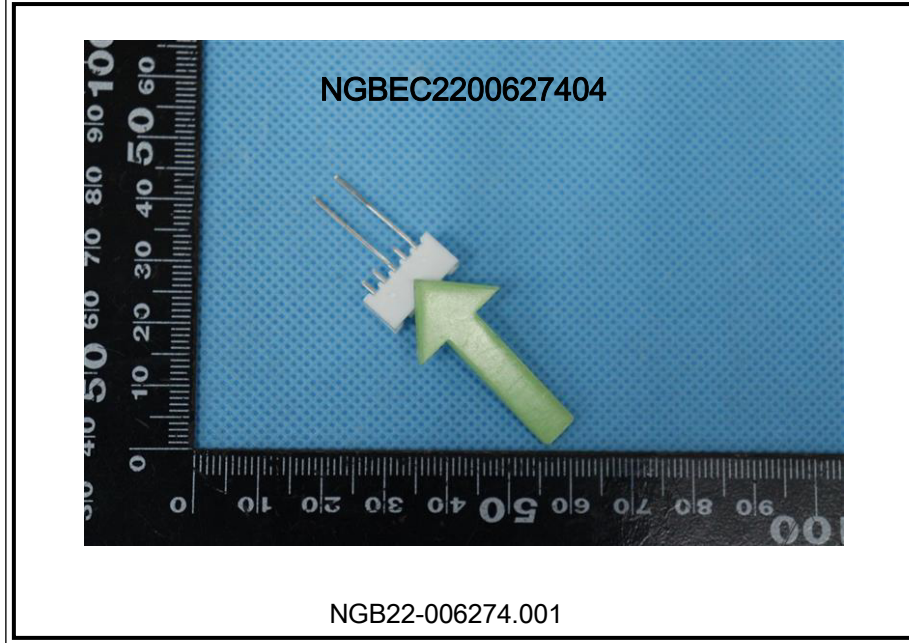
Phthalates 测试流程图



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*** 报告完 ***

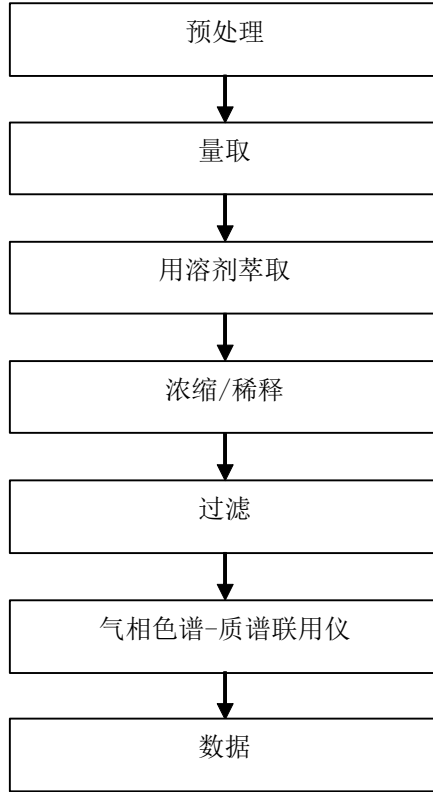

检测报告

编号: NGBEC2200697436

日期: 2022年04月27日

第1页,共10页

客户名称: 浙江联和电子有限公司
客户地址: 浙江省乐清市乐清湾港区乐商创业园

样品名称: LCP 连接器
型号: 1.25-4AB
客户参考信息: 见附件
以上样品及信息由客户提供。

SGS工作编号: NP22-001952 - NB
样品接收日期: 2022年04月21日
检测周期: 2022年04月21日 - 2022年04月27日
检测要求: 根据客户要求检测
检测方法: 请参见下一页
检测结果: 请参见下一页
结论: 基于所送样品的指定部位进行的检测, 镉、铅、汞、六价铬、多溴联苯(PBBs)、多溴二苯醚(PBDEs)、邻苯二甲酸酯(如邻苯二甲酸二丁酯(DBP)、邻苯二甲酸丁苯酯(BBP)、邻苯二甲酸二(2-乙基己基)酯(DEHP)和邻苯二甲酸二异丁酯(DIBP))的检测结果显示符合欧盟RoHS指令2011/65/EU附录II的修正指令(EU) 2015/863的限值要求。

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张倩倩

Ashley Zhang 张倩倩
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检测报告

编号: NGBEC2200697436

日期: 2022年04月27日

第2页,共10页

检测结果:

检测样品描述:

样品编号	SGS样品ID	描述
SN1	NGB22-006974.010	米黄色塑料部分

备注:

- (1) 1 mg/kg = 0.0001%
- (2) MDL = 方法检测限
- (3) ND = 未检出 (< MDL)
- (4) "-" = 未规定

RoHS指令2011/65/EU附录II的修正指令(EU) 2015/863

检测方法: 参考IEC 62321-4:2013+AMD1:2017, IEC 62321-5:2013, IEC 62321-7-2:2017, IEC 62321-6:2015和IEC 62321-8:2017, 采用ICP-OES,UV-Vis和GC-MS进行分析。

检测项目	限值	单位	MDL	010
镉(Cd)	100	mg/kg	2	ND
铅(Pb)	1000	mg/kg	2	ND
汞(Hg)	1000	mg/kg	2	ND
六价铬 (Cr(VI))	1000	mg/kg	8	ND
多溴联苯(PBBs)之和	1000	mg/kg	-	ND
一溴联苯	-	mg/kg	5	ND
二溴联苯	-	mg/kg	5	ND
三溴联苯	-	mg/kg	5	ND
四溴联苯	-	mg/kg	5	ND
五溴联苯	-	mg/kg	5	ND
六溴联苯	-	mg/kg	5	ND
七溴联苯	-	mg/kg	5	ND
八溴联苯	-	mg/kg	5	ND
九溴联苯	-	mg/kg	5	ND
十溴联苯	-	mg/kg	5	ND
多溴二苯醚之和(PBDEs)	1000	mg/kg	-	ND
一溴二苯醚	-	mg/kg	5	ND
二溴二苯醚	-	mg/kg	5	ND
三溴二苯醚	-	mg/kg	5	ND
四溴二苯醚	-	mg/kg	5	ND
五溴二苯醚	-	mg/kg	5	ND
六溴二苯醚	-	mg/kg	5	ND



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检测报告

编号: NGBEC2200697436

日期: 2022年04月27日

第3页,共10页

检测项目	限值	单位	MDL	010
七溴二苯醚	-	mg/kg	5	ND
八溴二苯醚	-	mg/kg	5	ND
九溴二苯醚	-	mg/kg	5	ND
十溴二苯醚	-	mg/kg	5	ND
邻苯二甲酸二丁酯 (DBP)	1000	mg/kg	50	ND
邻苯二甲酸丁苄酯(BBP)	1000	mg/kg	50	ND
邻苯二甲酸二(2-乙基己基)酯(DEHP)	1000	mg/kg	50	ND
邻苯二甲酸二异丁酯(DIBP)	1000	mg/kg	50	ND

备注:

(1) 最大允许极限值引用自RoHS指令(EU) 2015/863。

(2) IEC 62321 系列等同于 EN 62321 系列

https://www.cenelec.eu/dyn/www/f?p=104:30:1742232870351101:::FSP_ORG_ID,FSP_LANG_ID:1258637,25。

(3) 2021年7月22号开始, DEHP, BBP, DBP 和 DIBP的限制适用于医疗器械, 包括体外医疗器械, 监控仪表, 包括工业监测和控制仪器。

除非另有说明, 参照ILAC-G8:09/2019, 使用简单接受 ($w=0$) 的二元判定规则进行符合性判定。

除非另有说明, 此报告结果仅对检测的样品负责。本报告未经本公司书面许可, 不可部分复制。

检测报告仅用于客户科研、教学、内部质量控制、产品研发等目的, 仅供内部参考。



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检测报告

编号: NGBEC2200697436

日期: 2022年04月27日

第4页,共10页

附件:

XH, 1.0, SH, SHD, 1.25, 51021, DF14, DF13, GH, ZH, PH, PHB, PA, PHSD, DF11, C1251, 51047, 51146, FI-S, PHD, YHD200, PA, SMP, SMW, SMH, SMH200, SMH200-H, YH200, 20039WR, 杜邦2.0, XH/TJC3, XA, HA, XHB, XHD, XHE, EH, EI, 小四P, 5263, 5264, 5267, 5268, SZN, SAN, SCN, SCND, JC15, JC20, JC25, 5102, 5240, SMH250, SMP250, SMW250, 25048HS, 25045HP, SM, TJC8, 杜邦2.54, TJC8A, 杜邦带锁, TJC8B, TJC8H, 5051, 2510, 美尚美, 43640, 43645, 43020, 43025, 5500, 5600, VH, VHRR, YH396, VHR, 35156, 2139, 3.96, 90331, 5195, 5196, 39612, FL, 5557, 5559, 5566, 5569, SL, RV42, EL, YL, 小EL, 8981, 大四P, 5058, 5.08, L6.2, VL, VLP/VLR, TJC2, TJC2A, TJC2B, TJC4, TJC1, 1806, MX3.0, 1.58, 51005, 51006, BH3.5, BH4.0, 63080, 51004, TJC15, A4203, CL014, OTP, MKH, SMF, Cy-X201, 35108, 35150, 35151, 35224, 35180, 35965, 42021, 42022, 42002, 35955, SA, SCS, 35189, 35196, CH10, CH2.5, 543, SLP, SLR, YHL500, YWL500, FFC, FPC, 20030, 250, LGC, S11, YH025, 35155, 25415, 5197, 5198, 110, 2.8, 6.3, SCS

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检测报告

编号: NGBEC2200697436

日期: 2022年04月27日

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 D6302 D6303 D6304 D6305 D6306 D6307 D6308 D6309 D6201 D6202 D6203 D6204 D6205
 D6206 D6207 D6208 D6209 D7001 D7002 D7003 D7004 D7005 D7006 D7007 D7008 D7009
 F0501 F0502 F0503 F0504 F0505 F0506 F0507 F0508 F0509 F05010 F05011 F05012
 F05013 F05014 F05015 F05016 F05017 F05018 F1001 F1002 F1003 F1004 F1005 F1006 F1007
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 P0020 P0021 P0022 P0023 P0024 P0025 P0026 P0027 D2301 D2302 D2303 D2304 D2305
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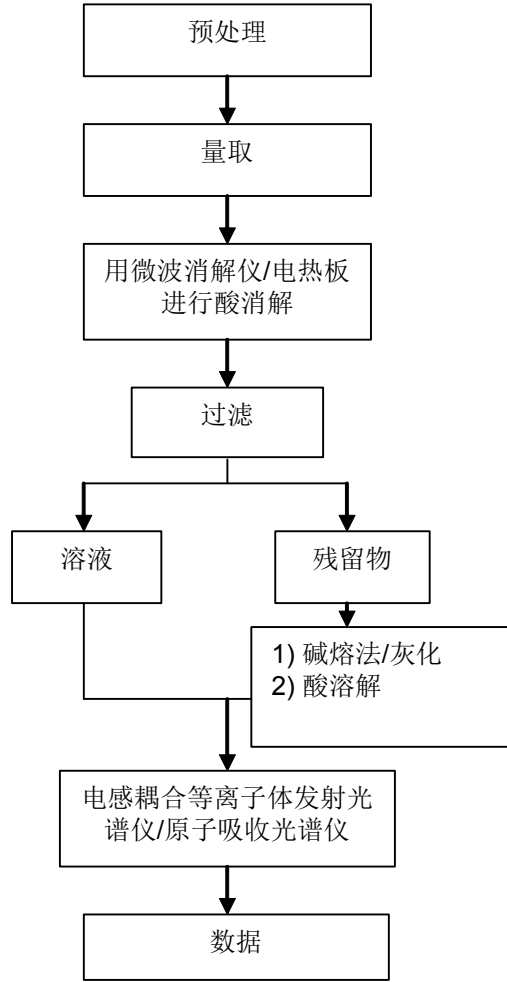


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附件


元素(IEC62321) 测试流程图

1)样品按照下述流程被完全消解



附件


六价铬测试流程图

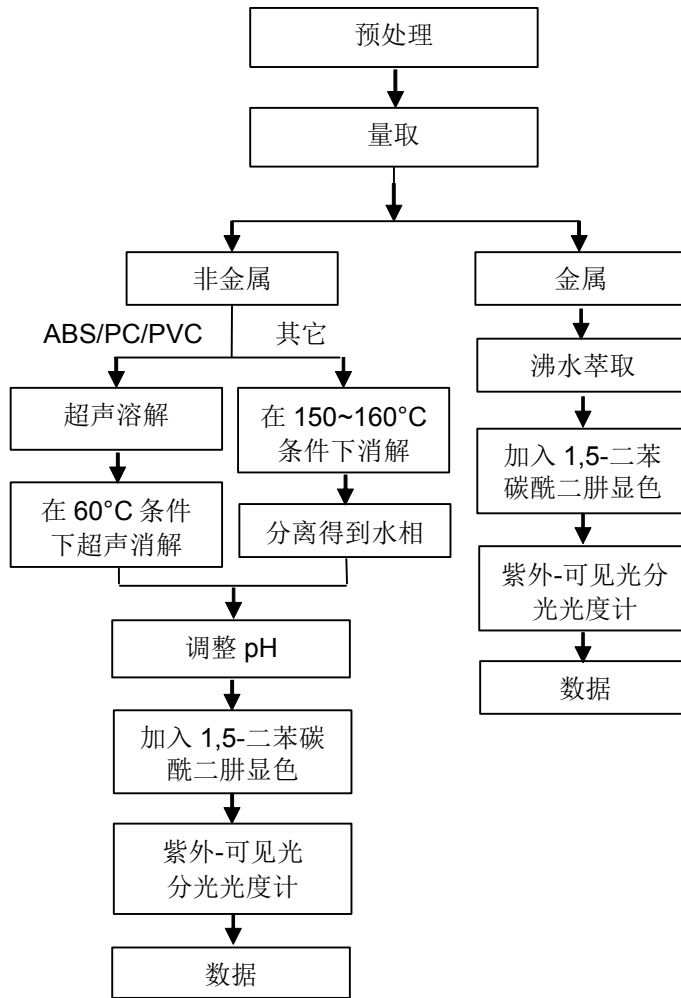

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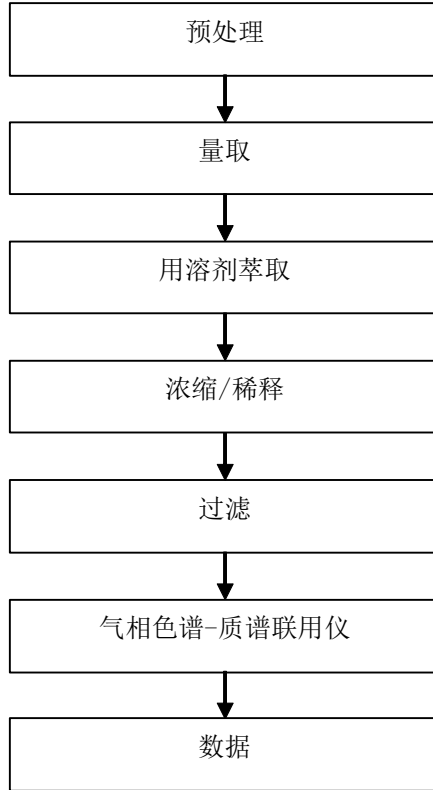
PBBs/PBDEs 测试流程图



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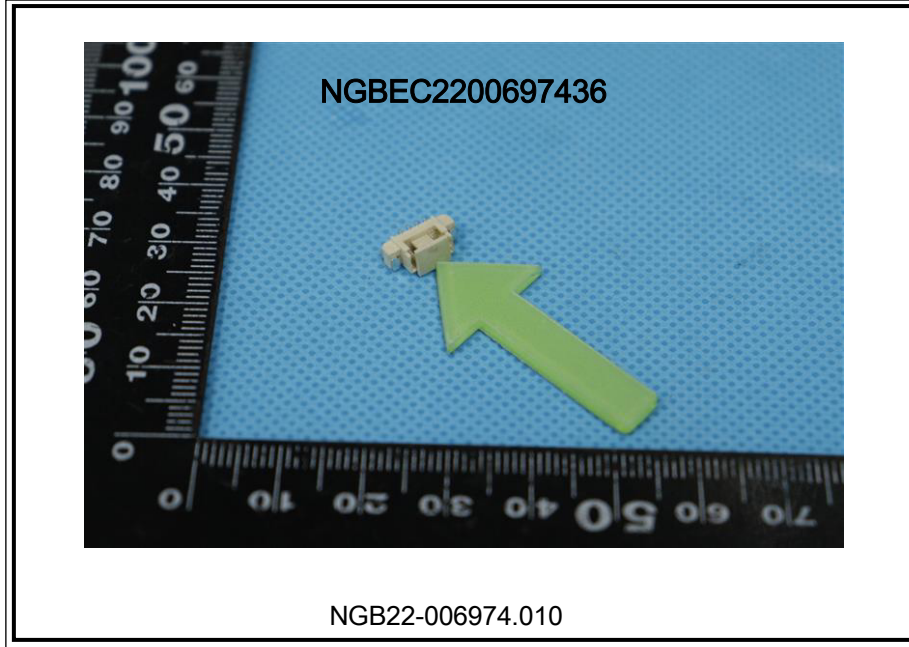
Phthalates 测试流程图

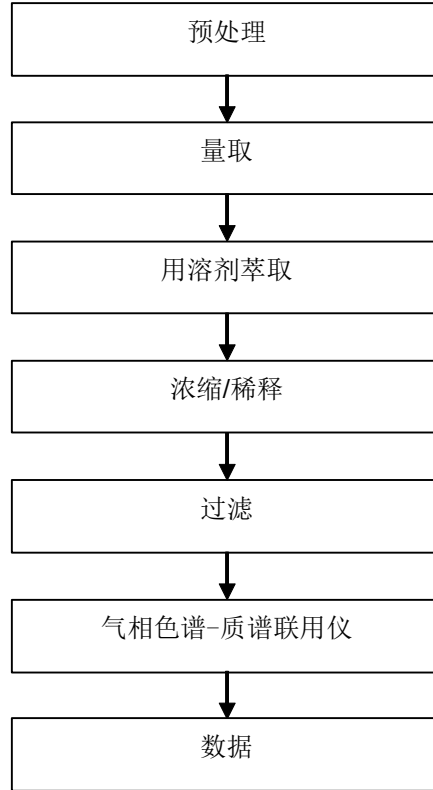

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*** 报告完 ***



检测报告

编号: NGBEC2200904704

日期: 2022年05月17日

第1页,共7页

客户名称: 浙江联和电子有限公司
客户地址: 浙江省乐清市乐清湾港区创新路8号
样品名称: 端子 针
客户参考信息: 见附件
以上样品及信息由客户提供。

SGS工作编号: NP22-002236 - NB
样品接收日期: 2022年05月07日
检测周期: 2022年05月07日 - 2022年05月17日
检测要求: 根据客户要求检测
检测方法: 请参见下一页
检测结果: 请参见下一页
结论: 基于所送样品进行的检测, 镉、铅、汞、六价铬的检测结果显示符合欧盟RoHS指令2011/65/EU附录II的修正指令(EU) 2015/863的限值要求。

通标标准技术服务有限公司宁波分公司
授权签名

张倩倩

Ashley Zhang 张倩倩
批准签署人

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检测报告

编号: NGBEC2200904704

日期: 2022年05月17日

第2页,共7页

检测结果:

检测样品描述:

样品编号	SGS样品ID	描述
SN1	NGB22-009047.001	银色金属

备注:

- (1) 1 mg/kg = 0.0001%
- (2) MDL = 方法检测限
- (3) ND = 未检出 (< MDL)
- (4) "-" = 未规定

RoHS指令2011/65/EU附录II的修正指令(EU) 2015/863

检测方法: 参考IEC 62321-4:2013+AMD1:2017, IEC 62321-5:2013 和 IEC 62321-7-1:2015, 采用ICP-OES和UV-Vis 进行分析.

检测项目	限值	单位	MDL	001
镉 (Cd)	100	mg/kg	2	ND
铅(Pb)	1000	mg/kg	2	5
汞 (Hg)	1000	mg/kg	2	ND
六价铬(Cr(VI))▼	-	µg/cm ²	0.10	ND

备注:

- (1) 最大允许限值引用自RoHS指令(EU) 2015/863。
- (2) IEC 62321 系列等同于 EN 62321 系列
https://www.cenelec.eu/dyn/www/f?p=104:30:1742232870351101:::FSP_ORG_ID,FSP_LANG_ID:1258637,25
- (3) ▼ = a. 当六价铬的浓度高于0.13 µg/cm²时, 样品为阳性, 即含有六价铬;
 b. 当六价铬的浓度为ND(低于0.10 µg/cm²)时, 样品为阴性, 即未检测到六价铬;
 c. 当六价铬的浓度介于0.10 µg/cm²与0.13 µg/cm²之间时, 无法直接判定是否检测到六价铬, 因不同个体的样品表面差异可能会影响测定结果;
 由于未获知样品的存储条件和生产日期, 样品的六价铬测试结果仅能代表测试时样品含六价铬的状态。
 除非另有说明, 参照ILAC-G8:09/2019, 使用简单接受 (w=0) 的二元判定规则进行符合性判定。
 除非另有说明, 此报告结果仅对检测的样品负责。本报告未经本公司书面许可, 不可部分复制。
 检测报告仅用于客户科研、教学、内部质量控制、产品研发等目的, 仅供内部参考。



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附件:

XH, 1.0, SH, SHD, 1.25, 51021, DF14, DF13, GH, ZH, PH, PHB, PA, PHSD, DF11, C1251, 51047, 51146, FI-S, PHD, YHD200, PA, SMP, SMW, SMH, SMH200, SMH200-H, YH200, 20039WR, 杜邦2.0, XH/TJC3, XA, HA, XHB, XHD, XHE, EH, EI, 小四P, 5263, 5264, 5267, 5268, SZN, SAN, SCN, SCND, JC15, JC20, JC25, 5102, 5240, SMH250, SMP250, SMW250, 25048HS, 25045HP, SM, TJC8, 杜邦2.54, TJC8A, 杜邦带锁, TJC8B, TJC8H, 5051, 2510, 美尚美, 43640, 43645, 43020, 43025, 5500, 5600, VH, VHRR, YH396, VHR, 35156, 2139, 3.96, 90331, 5195, 5196, 39612, FL, 5557, 5559, 5566, 5569, SL, RV42, EL, YL, 小EL, 8981, 大四P, 5058, 5.08, L6.2, VL, VLP/VLR, TJC2, TJC2A, TJC2B, TJC4, TJC1, 1806, MX3.0, 1.58, 51005, 51006, BH3.5, BH4.0, 63080, 51004, TJC15, A4203, CL014, OTP, MKH, SMF, Cy-X201, 35108, 35150, 35151, 35224, 35180, 35965, 42021, 42022, 42002, 35955, SA, SCS, 35189, 35196, CH10, CH2.5, 543, SLP, SLR, YHL500, YWL500, FFC, FPC, 20030, 250, LGC, S11, YH025, 35155, 25415, 5197, 5198, 110, 2.8, 6.3, SCS
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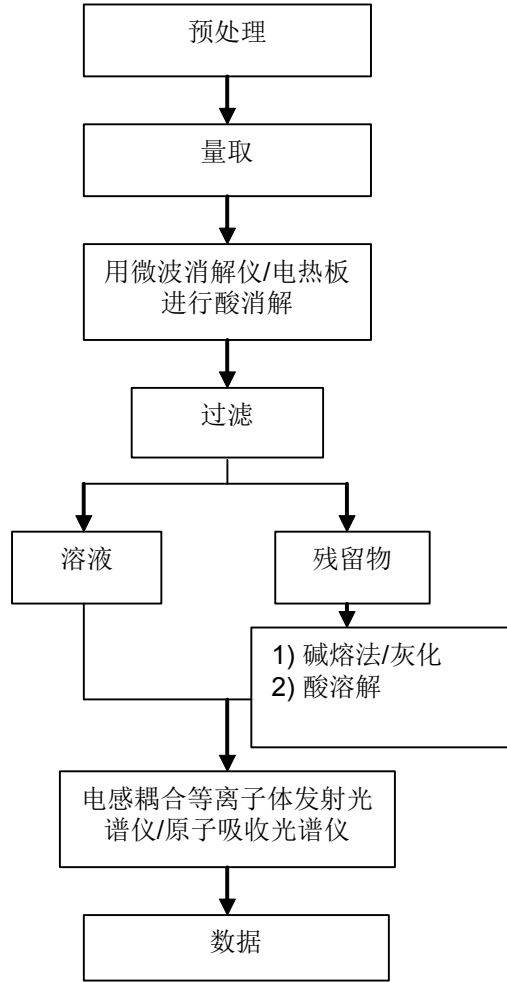
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附件


元素(IEC62321) 测试流程图

1)样品按照下述流程被完全消解



附件

六价铬测试流程图

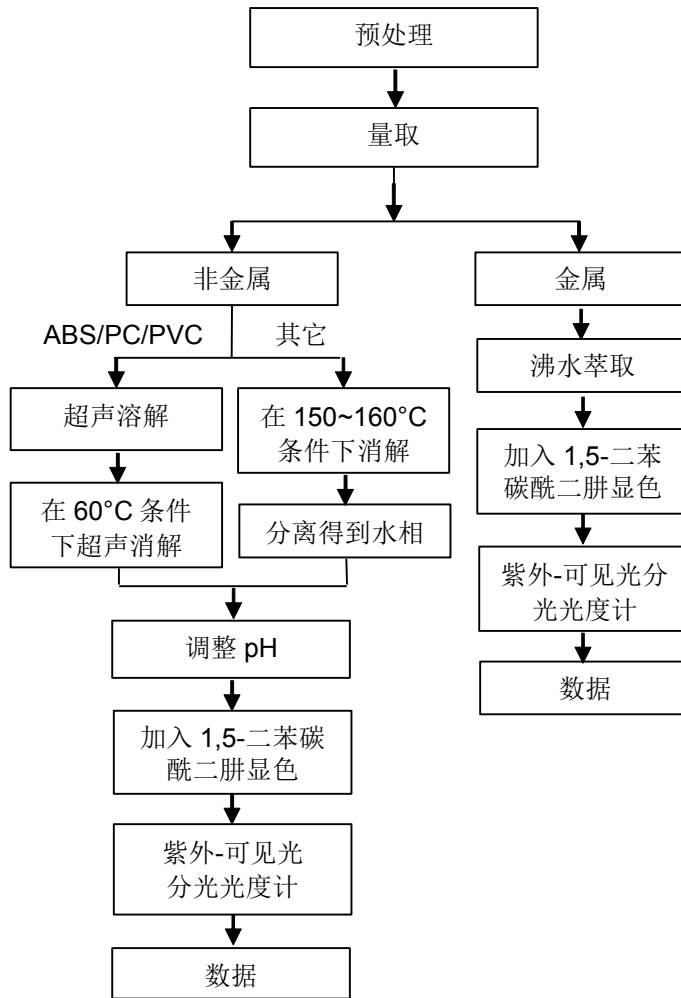

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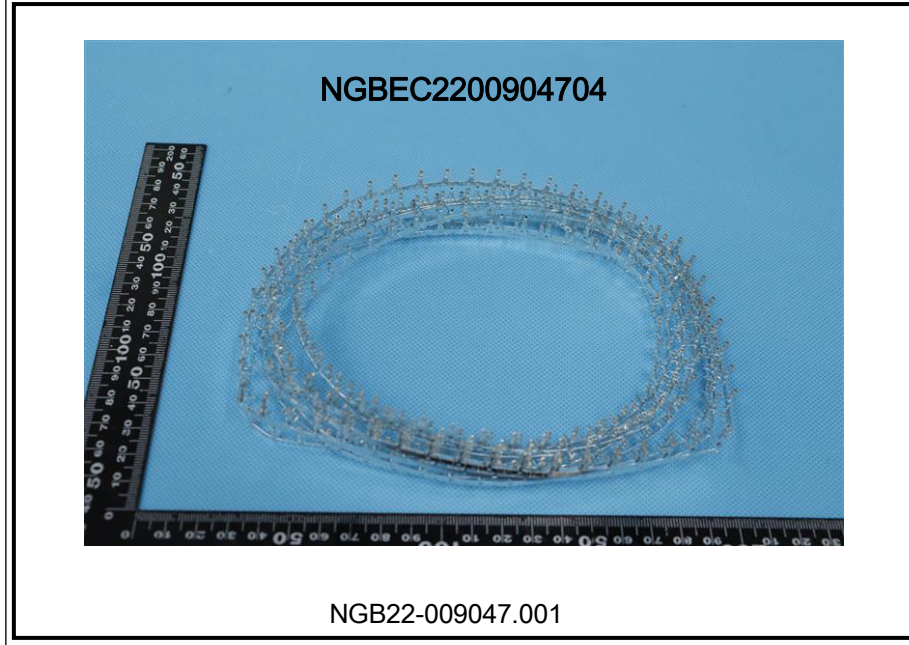
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样品照片:



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*** 报告完 ***



产品名称： PA66

版本日期： 15/03/2017

化学 品 安 全 说 明 书

MSDS

第一部分：化学制品、产品或公司信息

产品名称： PA66

产品别名：聚酰胺

责任方：浙江联和电子有限公司

一般用途:工程热塑性塑料



MSDS编号: PA66

第二部分：合成物或成分信息

组成部分：成分 CAS号码基础树脂 32131-17-2这是一种聚合物材料。所有成分和聚合物系统紧密结合，因此，目前正常的加工和处理情况下没有存在接触的可能性。本产品可能含有专利成分。根据美国《职业安全与卫生条例》，本产品没有被归类为危险品，此化学品安全说明书包含关于安全处理和合理使用本产品的有价值的重要信息。该说明书应妥善保管以便员工或其他使用该产品的用户使用。本产品不受加拿大《工作场所危险物质信息系统》管制。

第三部分：危险鉴定

紧急情况概述：轻微的不规则颗粒物状。燃烧分解可能会产生有危害性的气体基础树脂粉尘或粉末在美国矿务局相关粉尘爆炸的危害等级为低级。熔料可能会导致皮肤或眼睛接触性的热灼伤。此外，溢出的固体硬颗粒可能会造成滑倒的危险。

潜在健康影响：接触方式:皮肤和眼睛接触；气体吸入，如果温度过热的话。征兆症状：没有相关的具体资料。

即刻健康影响：

皮肤：本产品没有相关的具体资料。产品中可能含有的聚合物颗粒和纤维增强也可能造成机械性的伤害。热性或融化材料有潜在的可能导致热灼伤。

眼睛:本产品没有相关的具体资料。产品中可能含有的聚合物颗粒和纤维增强也可能造成机械性的伤害。

吸入： 本产品没有相关的具体资料。从供应的形式来看，本产品不存在被吸入的危险；然而聚合物颗粒可能被认为是一种惰性的微害微粒。加热过程中可能会有产生刺激性气体的危险。

摄入： 本产品没有相关的具体资料。但是，基于高分子聚合物的生物活性，摄取本产品预计会造成轻微的毒性。

长期或滞后影响： 没有相关的具体资料。

致癌性： 国际癌症研究机构（IARC）曾评估过本产品中可能含有的碳黑，并发现它可能对人类有致癌性（2B组）。本产品中的任何碳黑成分都被聚合物体系紧密结合，因此，目前正常的加工和处理情况下致癌的几率很小。

医疗条件

风险加剧： 本产品没有相关的具体资料。废气可能会被释放，如果过热的话，会影响那些有呼吸系统慢性疾病的人。

第四部分：急救措施

皮肤：如果烫的或熔化的聚合物或者热气接触皮肤，迅速用冷水降温。如果聚合物被粘在皮肤上，不要擅自去除，但是允许粘附的聚合物自然脱落，应寻求医学处理。相比聚合物随着时间推移自行脱落而言，擅自去除粘在皮肤上的聚合物，可能会造成更多的组织损伤。

眼睛：用大量的水冲洗。如果仍旧不舒适，应寻求医疗处理，去除异物。

吸入：转移到空气新鲜之处。如果呼吸困难的情况仍然发生，应寻求医学处理。

摄入：如果相当数量的本产品被吞咽，应饮用两杯水来稀释，并寻求医学处理。

医生注意事项：本产品本质上是惰性和无毒的。然而，如果被加热到高温或被燃烧，可能会有气体排放出来（见第五和第十部分的气体排放）。在这些排放的气体中，一氧化碳和一氧化氮有可能具有显著的临床毒性。那些曾暴露在有毒气体中的患者需要检查碳氧血红蛋白水平和动脉血气。如果一个酸中毒患者的碳氧血红蛋白水平是正常的，考虑氰化物毒性。如果患者与气体的接触发生在密闭空间内，则存在窒息（二氧化碳逐渐替代氧气）发生的可能性。一氧化氮对呼吸道有着强烈的刺激性。如果患者可能已经吸入高浓度和刺激性的烟雾，应考虑监测肺水肿病延后发生的可能。

第五部分：救火措施

闪点:不适用

危险燃烧产物：一氧化碳、二氧化碳和氮氧化物

灭火介质：水、泡沫材料、二氧化碳或干化学制

剂灭火指南：消防人员应携带自给式呼吸器和全套防护服。消防人员避免逆风救火。水应该用来给火灾中各种容器的降温。水、泡沫和干化学制剂可能会对电气设备造成损伤。

第六部分：意外泄漏对策

泄漏处理程序：用适当工具清扫泄漏场所，收集泄漏物料，以便恢复和处理。

第七部分：处理和储藏

处理：没有合适的器械，不要处理烫的或者熔化的物料。工作场所应保持整洁有序。不要超过推荐的温度，使分解产物的释放的小化。不要在有聚合物粉尘存在的场所抽烟。在传输和加工的过程中，应采取恰当的措施控制粉尘的产生和积累。

储藏：储藏在阴凉干燥的场所，保证树脂的干燥度。

第八部分：接触控制 /个人防护

工程控制：局部排气：建议在适当的时候以控制员工接触粉尘或蒸汽。总体而言，作为控制员工暴露在粉尘或者蒸汽中的唯一手段，此办法恐怕不能满足需要。

装备推荐：

皮肤：加热或熔化过程中，有机会接触物料时应穿着长裤、长袖、隔热手套和面罩。

眼睛：推荐安全眼罩。

吸入：如果粉尘或分解气体的产生有可能高于所允许接触的上限值，推荐使用经国家职业安全与健康研究所认证的防毒面罩 /口罩。

接触指导方针：本产品中可能含有的任何玻璃颗粒被聚合物系统紧密结合。残留的玻璃颗粒（<1%）可能存在，导致机械性的眼部、皮肤和呼吸刺激。包括机械加工或磨削在内的操作或部分应加以审查，以确保颗粒水平低于推荐的标准，本产品可能含有炭黑。见下列的接触极限值。

成分	机构	参数
炭黑	美国职业安全与健康条例 -允许接触极限	3.5 mg/cu m
	美国政府工业卫生专家会议 -临界值限定	3.5 mg/cu m
微害惰性粉尘	美国职业安全与健康条例 -允许接触极限	15 mg/cu m (全部) 5 mg/cu m (可吸入)
微害颗粒/微粒	美国政府工业卫生专家会议 -临界值限定	10 mg/cu m (全部) 3 mg/cu m (可吸入)

第九部分：物理和化学特性

外观：颗粒状物

气味：轻微的典型气味

物理状态：固态

气压：不适用

熔点（树脂）： 265°C（509°F）

溶解性：可忽略不计 < 0.1%（水）

比重： 1.40~1.50

挥发率： < 0.5按重量计

第十部分：稳定性和反应性

化学稳定性：在通常使用和储存条件下保持稳定

避免条件：燃烧：不要加热超过 650°F（343°C）。避免长时间暴露在温度高于 600°F（316°C）的环境。

不能共存性：强酸和氧化剂

危险分解物：一氧化碳、氨 /氨水、脂族胺、氨基化合物/酰胺、酮、腈和氢氰酸。

危险聚合反应：不会发生。

第十一部分：毒物学信息

本产品没有相关的具体资料。

第十二部分：生态学信息

生物毒性：对于树脂颗粒可能被野生动物摄入所造成的影响，我们还不是很清楚。如果是海鸟，一些海洋生物学家认为，鸟类消化道可能无法让塑料颗粒通过。因此，大量摄入颗粒可能会导致肠堵塞，饱食的错觉或营养吸收的减少，从而导致营养不良和饥饿。由塑料工业协会的发起的‘彻底清除行动’（OCS）的目标就是实现塑料颗粒零损失，防止其输入环境。

环境结果/信息：此材料被认为是不可生物降解的。

第十三部分：处置条件

处置：鼓励回收。按照当地政策法规处置本产品。

第十四部分：运输信息

不适用

第十五部分：法规信息

<美国>《有毒物质管理法》：

本产品的所有成分符合有毒物质管理法目录条例。

<美国>《超级基金增补和再授权法案》： 本产品不包含任何受限于《紧急规划和社区知权法》（1986）第 313章和《联邦法规汇编》第 40标题第 372部分中的报告规定的有毒化学物质。

第十六部分：其它信息

危害等级：	健康	可燃性	反应性	其它
国家防火协会	1	1	0	
危险物质鉴别系统	1	1	0	

否认声明： 本产品不适用于作为医学或牙科植入物的使用。为获取详细的工艺指导和良好的生产实践（净化、工艺参数、停炉等），请参阅相应的大赛璐公告。据我们所知，这里所含的信息是正确的。我们没有暗示或者保证此文件所列出的危险已经包含全部危险。大赛璐不做任何关于在你方工艺或与其他物质结合过程中安全使用本产品的明示或暗示性的保证。本产品的使用效果可能会因为其他材料的使用而恶化；或者说本产品可能增强，也可能恶化其他材料的使用效果。用户有其责任对任何使用或者使用方式加以仔细考虑并确定物料的适用性。用户必须符合所有适用的安全和健康标准。

编号：LHES006

MSDS

1. 物品成分与厂商资料

厂商名称：浙江联和电子有限公司	物品编号：QSN6.5-0.1
	物品名称：磷铜端子
	纯物质：
	有害物质成分（%）无

2. 成份辨识资料

成份名称	化学文摘社登记号码(CAS No.)	浓度范围（成分百分比 Percentage %）
铜(Cu)	7440-50-8	余量
磷(P)	7723-14-0	0.0026-0.005%
锌(Zn)	7440-66-6	0.03-0.04%
镍(Ni)	7440-02-0	0.054-0.063%
锑(Sb)	7440-36-0	0.00015%
铅(Pb)	7439-92-1	<0.005%
铁(Fe)	7439-89-6	0.005-0.0059%
纯镍(Ni)	7440-02-0	0.054-0.063%
纯锡(Sn)	7440-31-5	6.2 %

2. 危害辨认资料

严重危害效应	健康危害效应：本产品为固体时不具健康危害及危害
	环境影响：本产品为固体时对环境不具影响
	物理性及化学性危害：固体/无味/多色
	特殊危害：固体时（防火或高温）无特殊危害

主要症状：无

3. 急救措施

急救方法	吸入：无吸入
	皮肤接触：接触无危害
	食入：无食入

主要症状及危害效应：无

4. 灭火措施

通用灭火器：二氧化碳，泡沫，干粉化学灭火器，水雾等
灭火时可能遭遇之特殊危害：会引起火灾
消防人员之特殊防护装备：使用从氧式吸防护具

5. 泄漏处理方法

个人应注意事项：注意工作台面清洁，作业时及时清洗手
环境注意事项：将泄漏之物料以容器盛装以便回收或废弃
清理方式：工作台面每天作业前/后须擦拭干净，建议可以戴手套或手指套作业

6. 安全处置与储存方法

处置：废弃物可送到政府许可的废弃物处理中心进行处理

储存：空调仓，23±5℃，湿度 65%以下，仓库里面安装灭火器	
7. 暴露预防措施	
个人防护设备	呼吸防护：口罩，一般无此要求，可以建议采用
	手部防护设备：手套火手指套，一般无此要求，可以建议采用
	眼睛防护：安全目镜或眼镜
	皮肤及身体防护：穿工作服，经常勤洗
卫生措施：建议使用安全目镜，进食前应洗手及脸部，平时多运动，保持健康体力	
8. 物料及化学性质	
物质状态：固体	形状：连接器
颜色：多色	气味：无味
PH 值：未测定	沸点：未测定
分解温度：未测定	爆炸介限：无
自然温度：固体无	溶解度：固体无
9. 安全性及反应性	
安全性：正常状态下安全	
特殊状况下可能之危害反应：无	
应避免之状况：避免接触火源和太阳光直射	
应避免之物质：火和酸碱性物质	
危害分解物：无	
10. 毒性资料	
急毒性	吸入：无
	皮肤接触：无
	眼睛：无
局部效应：无	特殊效应：无
11. 废弃物处理方法：废弃物可送到政府许可的废弃物处理中心进行处理	
12. 运送资料	
联合国编号：无	运输规定：并无危险分类
运送方法及注意事项：勿重压，轻拿轻放	
13. 适用法规：1.劳工安全卫生设施规划；2.危害物及有害物通讯规划；3.索尼环境通用规定；4 劳工用业环境空气中有害物容许溶度标准；5 道路交通安全规划	
14. 其他资料：	
15.法规资料	
适用法规	1.劳工安全卫生设施规则 2.RoHS 法规及有害物通识规则
16.其它资料	
参考文献	有害化学物质中文资料库，环保局
制表单位	浙江联和电子有限公司
制造商及供应商地址	浙江省温州乐清市乐清湾港区创新路8号
电话	0577-62383699
制表者	季育文
制表日期	2021-3-23

编号：LHE-S006

成品 MSDS

1. 物品成分与厂商资料

厂商名称：浙江联和电子有限公司	物品编号：LHE-WF1001
	物品名称：黄铜镀锡针
地址：浙江省温州乐清市乐清湾港区创新路8号	纯物质：
联络电话：0577-62383699	有害物质成分（%）无

2. 成份辨识资料

成份名称	化学文摘社登记号码(CAS No.)	浓度范围（成分百分比 Percentage %）
铜(Cu)	7440-50-8	64.9%
磷(P)	7723-14-0	0.001%
锌(Zn)	7440-66-6	余量
镍(Ni)	7440-02-0	0.01%
锑(Sb)	7440-36-0	0.001%
铅(Pb)	7439-92-1	<0.009%
铁(Fe)	7439-89-6	<0.1%
纯镍(Ni)	7440-02-0	0.05%
纯锡(Sn)	7440-31-5	0.1%

2. 危害辨认资料

严重危害效应	健康危害效应：本产品为固体时不具健康危害及危害
	环境影响：本产品为固体时对环境不具影响
	物理性及化学性危害：固体/无味/多色
	特殊危害：固体时（防火或高温）无特殊危害

主要症状：无

3. 急救措施

急救方法	吸入：无吸入
	皮肤接触：接触无危害
	食入：无食入

主要症状及危害效应：无

4. 灭火措施

通用灭火器：二氧化碳，泡沫，干粉化学灭火器，水雾等

灭火时可能遭遇之特殊危害：会引起火灾

消防人员之特殊防护装备：使用从氧式吸防护具

5. 泄漏处理方法

个人应注意事项：注意工作台面清洁，作业时及时清洗手

环境注意事项：将泄漏之物料以容器盛装以便回收或废弃

清理方式：工作台面每天作业前/后须擦拭干净，建议可以戴手套或手指套作业

6. 安全处置与储存方法

处置：废弃物可送到政府许可的废弃物处理中心进行处理

储存：空调仓，23±5℃，湿度 65%以下，仓库里面安装灭火器	
7. 暴露预防措施	
个人防护设备	呼吸防护：口罩，一般无此要求，可以建议采用
	手部防护设备：手套火手指套，一般无此要求，可以建议采用
	眼睛防护：安全目镜或眼镜
	皮肤及身体防护：穿工作服，经常勤洗
卫生措施：建议使用安全目镜，进食前应洗手及脸部，平时多运动，保持健康体力	
8. 物料及化学性质	
物质状态：固体	形状：连接器
颜色：多色	气味：无味
PH 值：未测定	沸点：未测定
分解温度：未测定	爆炸介限：无
自然温度：固体无	溶解度：固体无
9. 安全性及反应性	
安全性：正常状态下安全	
特殊状况下可能之危害反应：无	
应避免之状况：避免接触火源和太阳光直射	
应避免之物质：火和酸碱性物质	
危害分解物：无	
10. 毒性资料	
急毒性	吸入：无
	皮肤接触：无
	眼睛：无
局部效应：无	特殊效应：无
11. 废弃物处理方法：废弃物可送到政府许可的废弃物处理中心进行处理	
12. 运送资料	
联合国编号：无	运输规定：并无危险分类
运送方法及注意事项：勿重压，轻拿轻放	
13. 适用法规：1.劳工安全卫生设施规划；2.危害物及有害物通讯规划；3.索尼环境通用规定；4 劳工用业环境空气有害物容许溶度标准；5 道路交通安全规划	
14. 其他资料：	
15.法规资料	
适用法规	1.劳工安全卫生设施规则 2.RoHS 法规及有害物通识规则
16.其它资料	
参考文献	有害化学物质中文资料库，环保局
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制造商及供应商地址	浙江省温州乐清市乐清湾港区创新路8号
电话	0577-62383699
制表者	陈浙海
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